**APPLICANT** KUM & GO 1459 GRAND AVENUE DES MOINES, IOWA 50309 CONTACT: DAN GARNEAU P: (515) 457-6392

### **ARCHITECT**

**BRR ARCHITECTURE** 8131 METCALF AVE, SUITE 300 OVERLAND PARK, KS 66204

### **FIRE PROTECTION**

SOUTH ADAMS COUNTY FIRE DEPARTMENT 6050 SYRACUSE STREET COMMERCE CITY, CO 80022 CONTACT: RANDALL WEIGUM P: (303) 288-0835

### STORM DRAINAGE

CITY OF COMMERCE CITY **PUBLIC WORKS DEPARTMENT** 8602 ROSEMARY STREET COMMERCE CITY, CO 80022 P: (303) 289-8176

### **ENGINEERING CONSULTANT**

ENTITLEMENT AND ENGINEERING SOLUTIONS, INC. 501 S CHERRY STREET, SUITE 300 GLENDALE, CO 80246 **CONTACT: JOEL TOMPKINS** P: (303) 725-9962

### LANDSCAPE ARCHITECT

VALERIAN 970 YUMA STREET, SUITE 130 **DENVER, CO 80204 CONTACT: NATHANIEL RONEY** P: (303) 347-1200

### **WATER & SANITARY SEWER**

SOUTH ADAMS COUNTY WATER & SANITATION DISTRICT 6595 EAST 70th AVENUE COMMERCE CITY, CO 80037 CONTACT: JEFF NELSON P: (303) 288-2646

### **ELECTRIC/NATURAL GAS**

XCEL ENERGY 2070 S. VALENTIA ST. DENVER, CO 80231 CONTACT: MICHELLE FORD P: (303) 671-3928 LUKE GALLEGOS 303-416-2437

### **LEGAL DESCRIPTION**

DESCRIPTION RECITED IN SPECIAL WARRANTY DEED RECORDED OCTOBER 31, 2018 AT RECEPTION No. 2018000088032

LOT 1, BLOCK 1, DENNER SUBDIVISION,

AND THAT PART OF VACATED EUDORA DRIVE VACATED BY ORDINANCE No. V-60-96 RECORDED NOVEMBER 5, 1996 IN BOOK 4874 AT PAGE 289 AND RECORDED JUNE 9, 1997 IN BOOK 5026 AT PAGE 30,

EXCEPTING THEREFROM THAT PORTION CONVEYED TO THE CITY OF COMMERCE CITY IN DEED RECORDED MARCH 29, 1999, IN BOOK 5695 AT PAGE 987,

COUNTY OF ADAMS, STATE OF COLORADO.

### **BENCHMARKS**

ELEVATIONS ARE BASED UPON A POST-PROCESSED STATIC GNSS CONNECTION MADE TO NGS BENCH MARK E 392 (PID KK1298), BEING A STAINLESS ROD IN ACCESS COVER STAMPED E 392 1983 UTILIZING GEOID 12B TO MODEL THE ELLIPSOID SEPARATTION.

NGS ELEVATION: 5133.10 (NAVD 88).

### **BASIS OF BEARING**

BEARINGS ARE BASED UPON THE NORTH LINE OF THE NORTHEAST QUARTER OF SECTION 6, T 3 S, R 67 W, SAID LINE BEARING SOUTH 89°45'56" WEST RELATIVE TO THE COLORADO COORDINATE SYSTEM OF 1983, CENTRAL ZONE (STATE PLANE GRID) AS DETERMINED BY POST-PROCESSED STATIC GNSS OBSERVATIONS.

### FLOODPLAIN STATEMENT

THIS PARCEL LIES WITHIN ZONE X (AREAS DETERMINED TO BE OUTSIDE THE 0.2% ANNUAL CHANCE FLOODPLAIN), AS SHOWN ON FEMA FIRM PANEL No. 08001C0608H, REVISED MARCH 5, 2007.



**DEVELOPMENT PLAN** 

**KUM & GO GAS AND C-STORE** 

PART OF THE NORTHEAST QUARTER OF SECTION 6, TOWNSHIP 3 SOUTH, RANGE 67

WEST OF THE 6th P.M., CITY OF COMMERCE CITY, ADAMS COUNTY, COLORADO

**VICINITY MAP** 

SCALE: 1" = 500'

### SITE PLAN SHEET INDEX

S	HEET NO.	DESCRIPTION
	1	COVER SHEE
	2	SITE PLAN
	3	PRELIMINAR'

PRELIMINARY UTILITY PLAN DIMENSIONING PLAN

LANDSCAPE PLAN PLANTING SCHEDULE & NOTES LANDSCAPE DETAILS

EXTERIOR ELEVATIONS CANOPY ELEVATIONS TRASH ENCLOSURE ELEVATIONS

PHOTOMETRIC PLAN

### **COMMERCE CITY DEVELOPMENT PLAN NOTES**

- A. IN THE INTEREST OF COMPATIBILITY OF SURROUNDING LAND USES, ILLUMINATION OF ANY KIND ON PRIVATE PROPERTY SHALL BE DIRECTED AND CONTROLLED IN SUCH A MANNER SO THAT THERE SHALL BE NO DIRECT RAYS OF LIGHT WHICH EXTEND BEYOND THE BOUNDARIES OF THE PROPERTY FROM WHICH IT ORIGINATES.
- B. TRASH ENCLOSURES SHALL BE CONSTRUCTED TO A MINIMUM HEIGHT OF 6-FEET AND OF THE SAME OR COMPLIMENTARY MATERIAL AND COLOR AS THE MAIN BUILDING.
- C. ROOF MOUNTED ELECTRICAL AND MECHANICAL EQUIPMENT SHALL BE PLACED OR SCREENED SUCH THAT THE EQUIPMENT IS NOT VISIBLE FROM ANY POINT. SUCH EQUIPMENT SHALL BE SCREENED WITH THE SAME MATERIALS AND COLORS AS THE MAIN BUILDING.
- D. APPROVAL OF A SIGN PERMIT IS REQUIRED IN ADDITION TO DEVELOPMENT PLAN APPROVAL. SIGN LOCATIONS SHOWN ON THE DEVELOPMENT PLAN WILL BE REVIEWED FOR POSSIBLE CONFLICTS WITH SIGHT TRIANGLES AND EASEMENTS. THESE SIGNS WILL NOT BE APPROVED BY THE DEVELOPMENT PLAN REVIEW PROCESS OR APPROVAL OF THIS DEVELOPMENT PLAN. ALL SIGNS MUST CONFORM TO THE CITY'S STANDARDS.
- E. APPROVAL OF A FENCE PERMIT IS REQUIRED IN ADDITION TO DEVELOPMENT PLAN APPROVAL. ALL FENCES MUST CONFORM TO
- F. NO ROOF DOWNSPOUT OUTFALLS WILL BE ALLOWED TO DRAIN OVER SIDEWALKS, BIKE PATHS, OR ANY OTHER PEDESTRIAN ROUTE.
- G. THE APPLICANT HAS THE OBLIGATION TO COMPLY WITH ALL APPLICABLE REQUIREMENTS OF THE AMERICAN DISABILITIES ACT. APPROVAL OF THIS DEVELOPMENT PLAN DOES NOT CONSTITUTE COMPLIANCE WITH THIS ACT.
- H. THE APPROVAL OF THIS DEVELOPMENT PLAN DOES NOT CONSTITUTE FINAL APPROVAL OF GRADING, DRAINAGE, UTILITY, PUBLIC IMPROVEMENTS AND BUILDING PLANS. THESE PLANS MUST BE REVIEWED AND APPROVED BY THE APPROPRIATE AGENCY PRIOR TO THE ISSUANCE OF BUILDING PERMITS.
- I. ALL OVERHEAD UTILITIES SERVING THIS SITE MUST BE PLACED UNDERGROUND PER THE LAND DEVELOPMENT CODE.

### **PROJECT DATA**

GENERAL ADDRESS: 7160 EUDORA DRIVE LAND USE: GAS STATION/CONVENIENCE FOOD SALES BUILDING AREA: 3,968 SQ. FT. (C-STORE)

CONSTRUCTION TYPE: VB OCCUPANCY: M ESTIMATED No. EMPLOYEES: 16

NUMBER OF DISPENSERS: 8 PROJECT DESCRIPTION: THE PROPOSED DEVELOPMENT PLANS DETAIL THE CONSTRUCTION OF A CONVENIENCE STORE, GAS STATION, AND FUEL CANOPY WITH ASSOCIATED PARKING AND SITE WORK. TOTAL DEVELOPMENT PLAN AREA: 2.309 ACRES

EXISTING: I-2 PROPOSED: I-1

MAX. 75' MIN. 5' (INTERIOR) MIN. 15' (CORNER) MAX. N/A CANOPY

ALL PROPERTY LINES MIN. 40'

SUMMATION

PARKING REQUIRED MIN: 1 SPACE PER 200 SF OF GFA (3,968 SF/200) = 20 SPACES

150% OF MINIMUM = 30 SPACES 28 REGULAR SPACES 2 HANDICAP SPACES

2.309 ACRE

MAX. N/A

PARKING PROVIDED 25 SPACES TOTAL 23 REGULAR SPACES

1 HANDICAP SPACE 1 VAN ACCESSIBLE HANDICAP SPACE

### LAND USE SUMMARY

AREA 0.091 ACRE (3.5%, FAR) CANOPY 0.138 ACRE 0.833 ACRE PAVING LANDSCAPE 1.247 ACRE

### **CITY STAFF CERTIFICATE**

PPROVED BY THE DEPARTMEI	T OF COMMUNITY DEVELOPMENT OF THE CITY OF COMMERCE CITY, THIS	1
DAY OF	. 20	

CITY SIGNATURE



1459 Grand Ave Des Moines, IA 50309 P: 888-458-6646

S AND C-STORE COMMERCE CITY MENT PLAN

KG PROJECT TEAM: EES RDM: RF

SDM: DG

160

CPM:	BS			
REVISION DESCRIPTION	INITIAL SUBMITTAL			REVISIONS
DATE	07/07/2022			

07-07-2022

SHEET NUMBER:

# **DEVELOPMENT PLAN KUM & GO GAS AND C-STORE** PART OF THE NORTHEAST QUARTER OF SECTION 6, TOWNSHIP 3 SOUTH, RANGE 67 WEST OF THE 6th P.M., CITY OF COMMERCE CITY, ADAMS COUNTY, COLORADO SCALE IN FEET

EASEMENT

LOT 1, BLOCK 1

DENNER SUBDIVISION (1996)

(FILE 17, MAP 479, REC. C0138764)

100,567 S.F. (2.31± ACRES)

**SUBJECT** 

ADAMS CITY SUBDIVISION

BLOCK 18, LOTS 19-20

(REC. 2019000056312)

OWNER: 7100 EUDORA LLC

5' UTILITY & DRNG.

REC. CO138764 (TO BE VACATED)

EASEMENT - FILE 17, MAP 479 WIDTH VARIES

37.3

Ø∉TENTION/ESMT. WIDTH WARIES

FILE 17, MAP 479

REC. CØ138764

(TO BE VACATED)

UTILITY ESMT.

WIDTH VARIES

BOOK 5026, PG. 30

DRIVI ARIES 19 (1947)

ADAMS CITY SUBDIVISION. BLOCK 18, LOTS 1-4

(REC. 2021000016176) OWNER: RUDENTERPRISES LLC dba SANTIAGO'S MEXICAN

RESTAURANT

115.2

PROPOSED

ADAMS CITY SUBDIVISION

BLOCK 18, LOTS 33-40

(REC. 2019000056312)

OWNER: 7100 EUDORA LLC

### **LEGEND** PARCEL BOUNDARY PROPOSED SIDEWALK PROPOSED BOLLARD STRIP WITH COLORED, TEXTURED CONCRETE — — — — — PROPOSED EASEMENT PROSED BUILDING AND ENTRY PROPOSED FUELING POINT, CRASH PROTECTION, AND COLUMN PARKING COUNT PROPOSED SURFACE UTILITIES PROPOSED FUEL CANOPY LIMITS $\Theta$ PROPOSED SITE LIGHTS REFERENCE NOTE REFER TO DEVELOPMENT PLAN SHEET 5, DIMENSIONING PLAN, FOR DETAILED DIMENSIONS AND SERVICE VEHICLE SITE CIRCULATION. SITE SCHEDULE (1) PRIMARY BUILDING ENTRY 23) 14'-8" X 24'-8" TRASH ENCLOSURE. SEE ARCHITECTURAL (2) SECONDARY BUILDING ENTRY (24) UNDERGROUND FUEL STORAGE TANKS; 1 - 12K DIESEL, 1 - 12K (3) PROPANE CAGE (1 CAGE - 18 TANKS) PREMIUM, 1 - 12K E-85, 1 - 20K UNLEADED (4) MISCELLANEOUS MERCHANDISE (25) TANK ACCESS PORTS (5) FIREWOOD (26) INTEGRAL CONCRETE CURB (6) ICE VENDING (27) 4" DIAMETER BOLLARDS @ 5' O.C. (7) REDBOX (28) BROOM FINISHED CONCRETE (8) 40' FLAGPOLE, MAINTAIN Ø24' CLEAR SPACE ABOVE GRADE (29) PAINT CURB ALONG FRONT OF TANKS YELLOW (9) BOLLARD BIKE RACK ON 5.0' X 6.5' X 4" THICK CONCRETE PAD (30) DRIVEWAY ENTRANCE PAVEMENT MARKINGS (10) STOP SIGN (31) 8 PACK DOUBLE STACK FUELING CANOPY 11 TRANSFORMER PAD 32 ADA ROUTE 12 ADA RAMP (33) STORM INFRASTRUCTURE

### **GENERAL NOTES**

(13) 25' MONUMENT SIGN

(15) CONCRETE PAVEMENT

(17) PARKING STRIPE (TYP.)

(16) LOADING AREA

PLANS FOR EXACT LOCATION

(18) POST MOUNTED ADA VAN PARKING SIGN

(19) POST MOUNTED ADA PARKING SIGN

(20) ACCESSIBLE PARKING SPACE

(21) DETENTION & WATER QUALITY

DETENTION ESMT.

FILE 17, MAP 479 REC. CO138764

(TO BE VACATED)

5' UTILITY & DRNG.

FILE 17, MAP 479 REC. C0138764

EASEMENT

WIDTH VARIES

- 1. NO WORK IS TO BEGIN UNTIL NECESSARY PERMITS HAVE BEEN OBTAINED.
- 2. ENTIRE INSTALLATION SHALL MEET ALL APPLICABLE CODES

(14) PROPOSED CRASH PROTECTION - REFER TO ARCHITECTURAL

VERIFY ALL CONDITIONS AND DIMENSIONS ON SITE.

(22) AIR MACHINE LOCATION, 4'X4' CONCRETE PAD

- GENERAL CONTRACTOR TO COORDINATE ALL UTILITY WORK WITH THE APPROPRIATE UTILITY PROVIDER. GENERAL CONTRACTOR TO VERIFY AND FOLLOW ALL UTILITY PROVIDER REQUIREMENTS, PROCEDURES, STANDARDS AND SPECIFICATIONS.
- GENERAL CONTRACTOR TO PROVIDE ALL EQUIPMENT AND PERSONNEL REQUIRED FOR FINAL CHECKOUT OF ALL FACILITIES BY OWNER'S REPRESENTATIVE.
- GENERAL CONTRACTOR TO PERFORM GENERAL YARD AND BUILDING CLEAN-UP AT THE COMPLETION OF WORK.
- ALL PUBLIC IMPROVEMENTS SHALL BE IN ACCORDANACE WITH THE CITY OF COMMERCE CITY STANDARDS AND SPECIFICATIONS, LATEST REVISION THEREOF. IT IS RECOMMENDED THAT THE CONTRACTOR OBTAIN A COPY OF THESE MANUALS FROM COMMERCE CITY FOR REFERENCE DURING ALL SITE CONSTRUCTION.

(34) SITE LIGHTING; SEE PHOTOMETRICS PLAN

(39) PROPOSED CURB AND GUTTER WITHIN R.O.W.

(42) EXISTING STORM INFRASTRUCTURE TO REMAIN

(41) EXISTING CURB AND GUTTER TO REMAIN

(38) TRASH ENCLOSURE LATCH MECHANISM TO BE UNDER 44"

(37) EMERGENCY DISCONNECT SWITCH


(40) PROPOSED PUBLIC SIDEWALK

(43) PROPOSED 8' CROSS PAN

35 WATER METER

(36) KNOX BOX LOCATION

- GOVERNING AUTHORITY STANDARDS AND SPECIFICATIONS SHALL GOVERN SHOULD A DISCREPANCY ARISE BETWEEN THE STANDARDS AND SPECIFICATIONS AND THE PLANS. THE ENGINEER SHALL BE NOTIFIED IMMEDIATELY OF ANY DISCREPANCIES.
- ALL ASPHALT CUTS FOR UTILITIES AND PAVEMENT WITHIN PUBLIC RIGHT OF WAYS SHALL BE IN ACCORDANCE WITH COMMERCE CITY STANDARDS AND SPECIFICATIONS.
- 10. GENERAL CONTRACTOR SHALL PROVIDE COMPREHENSIVE TRAFFIC CONTROL PLAN WHICH SHALL BE SUBMITTED TO AND APPROVED BY COMMERCE CITY ENGINEERING DEPARTMENT PRIOR TO ANY WORK IN THE PUBLIC R.O.W. CONTRACTOR IS RESPONSIBLE FOR SAFETY TO THE PUBLIC BY MINIMIZING THE INTERRUPTION OF THE USE OF ROADS AND PROVIDING SIGNS, FLARES, BARRICADES, ETC. AS NECESSARY
- 11. IT SHALL BE THE CONTRACTOR'S RESPONSIBILITY TO VERIFY THE ACTUAL LOCATION AND ELEVATION OF EXISTING UTILITIES WHICH MAY BE IN CONFLICT WITH THE PROPOSED CONSTRUCTION. IF A CONFLICT DOES EXIST, THE CONTRACTOR SHALL NOTIFY THE ENGINEER PRIOR TO PROCEEDING.
- 12. IT SHALL BE THE CONTRACTOR'S RESPONSIBILITY TO NOTIFY ALL UTILITIES WHEN CONSTRUCTION WORK BEGINS IN THE VICINITY OF ANY UTILITY LINES AND TO ARRANGE FOR A REPRESENTATIVE OF THE UTILITY TO BE PRESENT IF THE CONTRACTOR'S OPERATIONS ARE IN CLOSE PROXIMITY TO ANY LINES IN THEIR EXISTING OR RELOCATED POSITION WHICH COULD CREATE A HAZARDOUS CONDITION.
- 13. CONTRACTOR SHALL BE RESPONSIBLE FOR ALL INSPECTION AND TESTING REQUIRED FOR APPROVAL OF WORK. 14. NOTES LOCATED ON ANY SHEET IN THE SET ARE APPLICABLE TO ENTIRE SET.

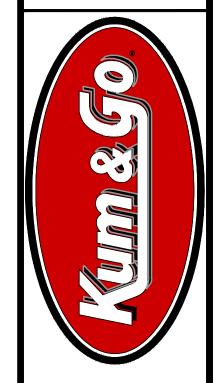

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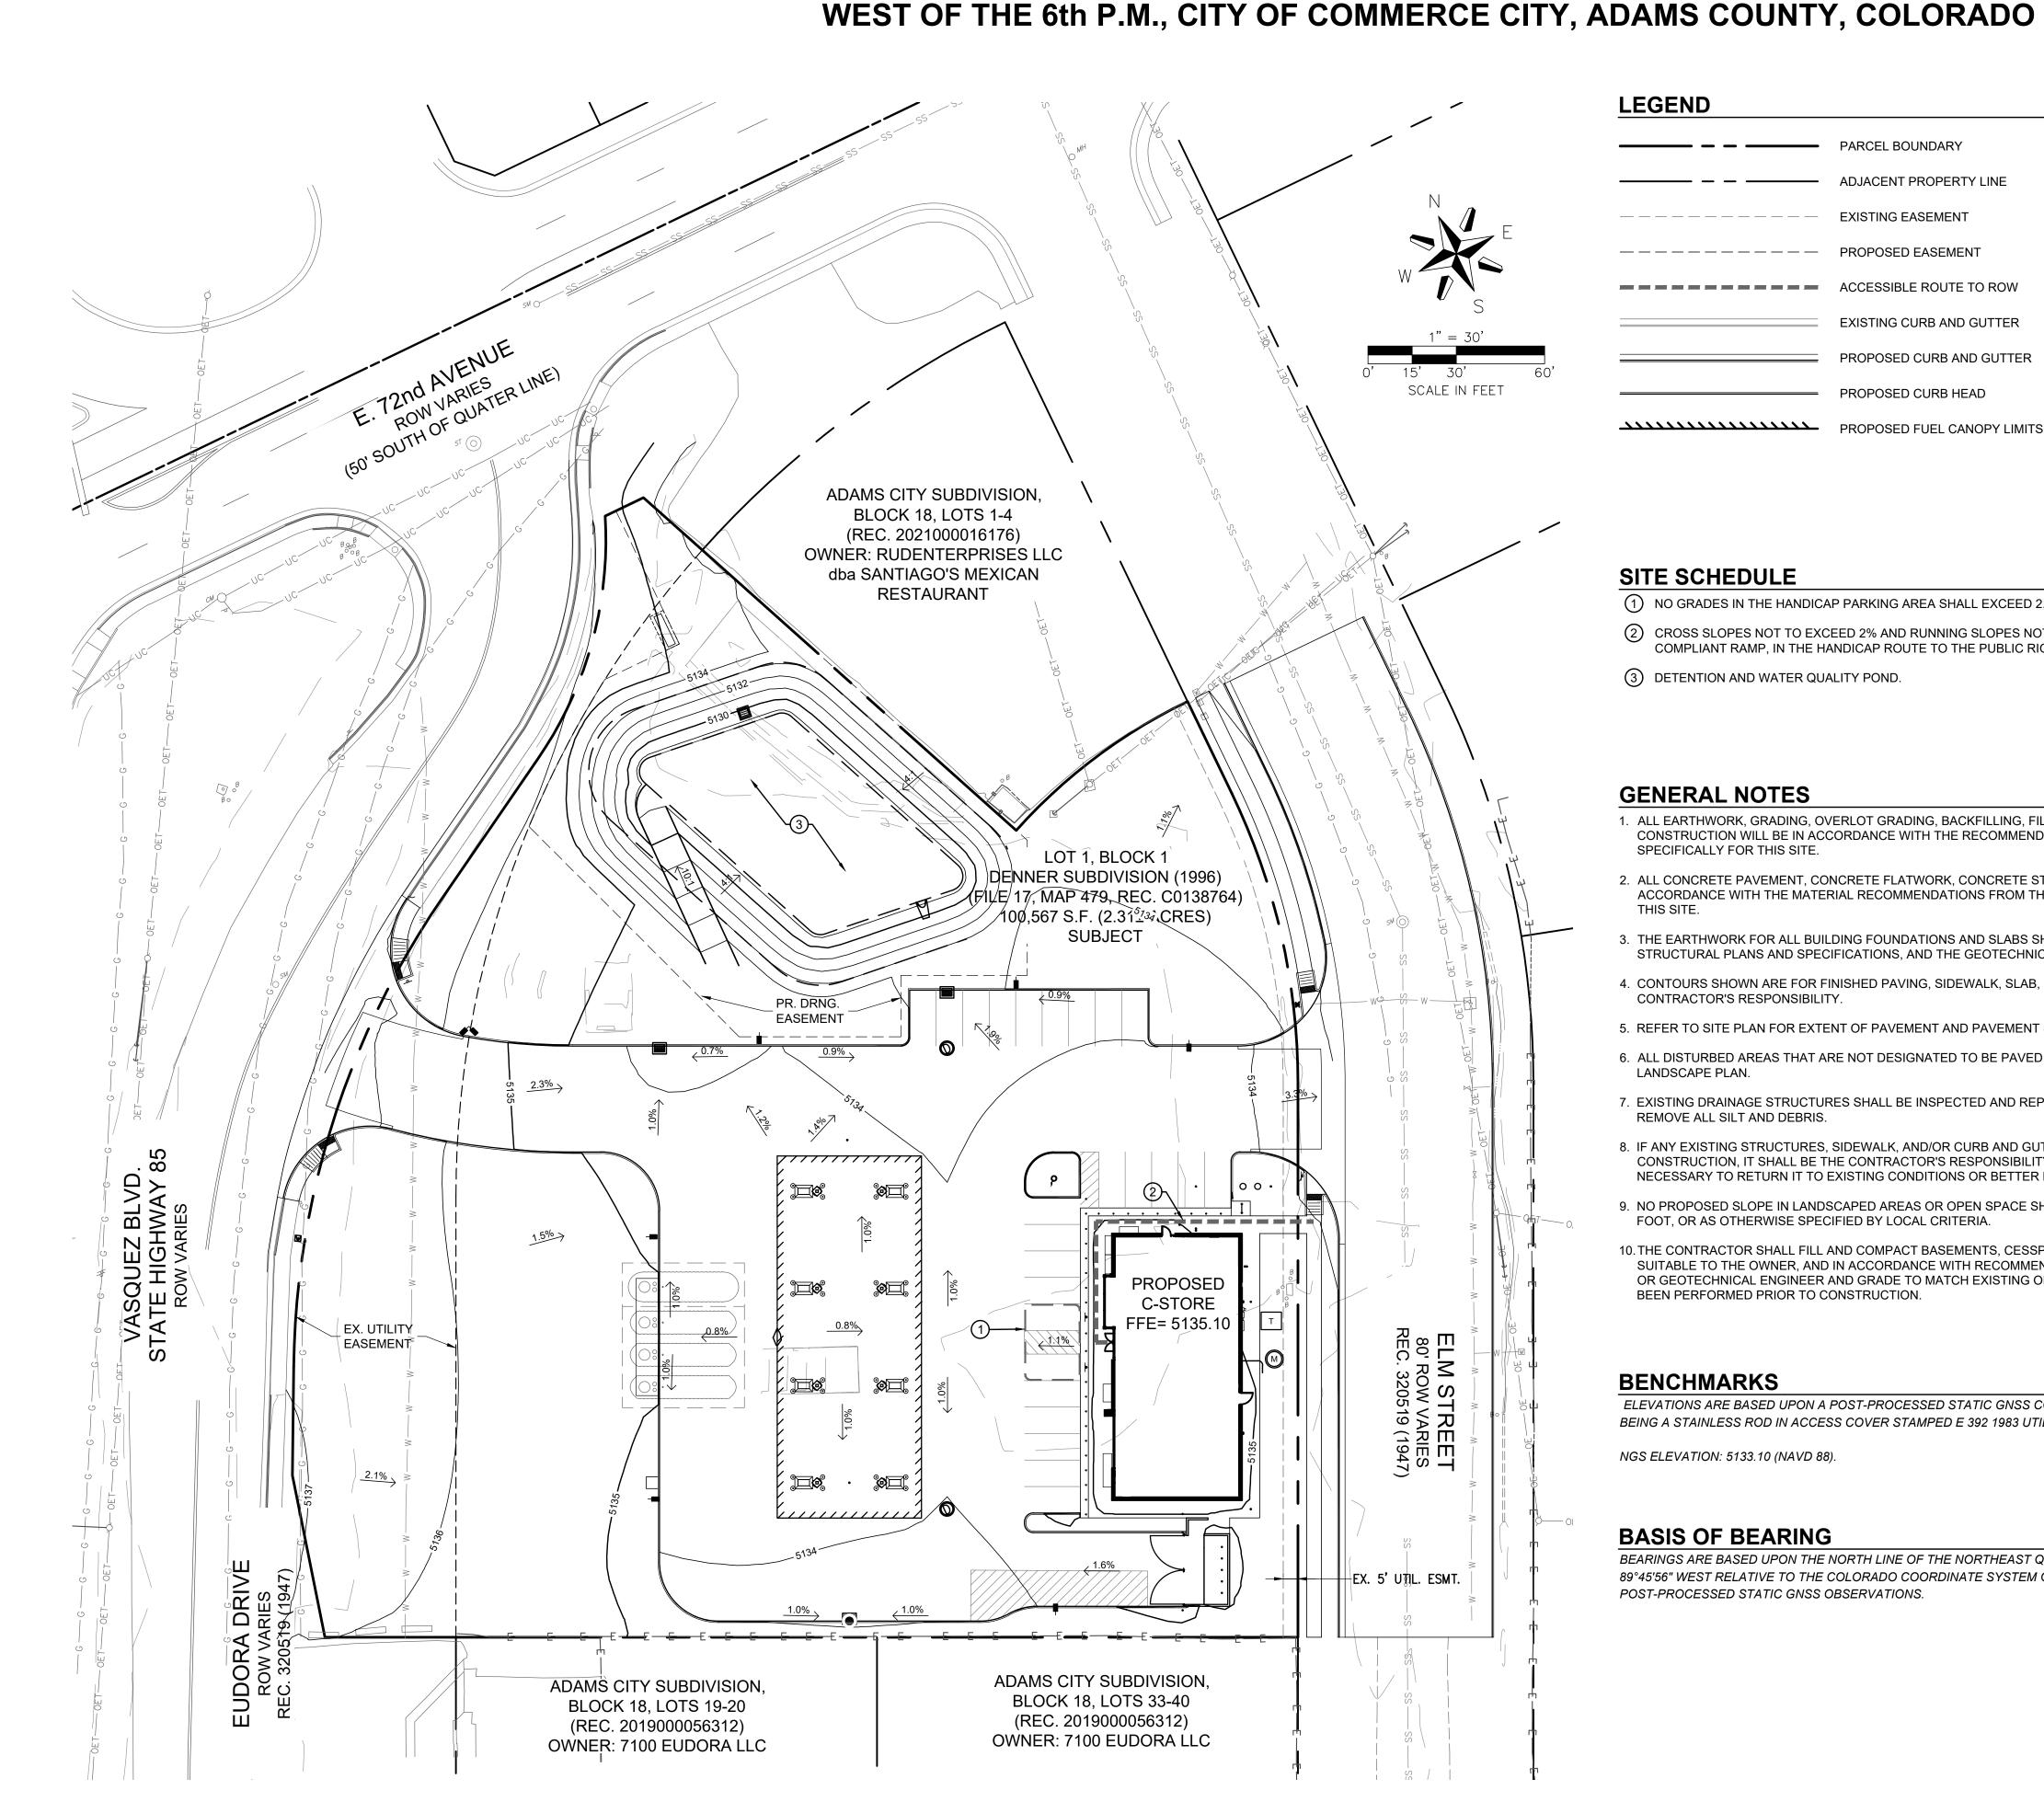
S AND C-STORE COMMERCE CITY

KG PROJECT TEAM: EES SDM: DG CPM: BS

160

07-07-2022

### **DEVELOPMENT PLAN KUM & GO GAS AND C-STORE** PART OF THE NORTHEAST QUARTER OF SECTION 6, TOWNSHIP 3 SOUTH, RANGE 67



**LEGEND EXISTING MINOR CONTOUR** PROPOSED SURFACE UTILITIES PROPOSED SITE LIGHTS PROPOSED CURB AND GUTTER PROPOSED FUEL CANOPY LIMITS

### SITE SCHEDULE

- NO GRADES IN THE HANDICAP PARKING AREA SHALL EXCEED 2.0% IN ANY DIRECTION.
- ig(2ig) CROSS SLOPES NOT TO EXCEED 2% AND RUNNING SLOPES NOT TO EXCEED 5%, EXCEPTING AS MAY BE PROVIDED BY A AADAG
- (3) DETENTION AND WATER QUALITY POND.

### **GENERAL NOTES**

- 1. ALL EARTHWORK, GRADING, OVERLOT GRADING, BACKFILLING, FILLING, EXCAVATION, COMPACTION, PAVEMENT, AND FLATWORK CONSTRUCTION WILL BE IN ACCORDANCE WITH THE RECOMMENDATIONS FROM THE GEOTECHNICAL INVESTIGATION PREPARED
- ACCORDANCE WITH THE MATERIAL RECOMMENDATIONS FROM THE GEOTECHNICAL INVESTIGATION PREPARED SPECIFICALLY FOR
- 3. THE EARTHWORK FOR ALL BUILDING FOUNDATIONS AND SLABS SHALL BE IN ACCORDANCE WITH ARCHITECTURAL AND STRUCTURAL PLANS AND SPECIFICATIONS, AND THE GEOTECHNICAL INVESTIGATION.
- 4. CONTOURS SHOWN ARE FOR FINISHED PAVING, SIDEWALK, SLAB, OR GROUND. ADJUSTMENT TO SUBGRADE IS THE CONTRACTOR'S RESPONSIBILITY.
- 5. REFER TO SITE PLAN FOR EXTENT OF PAVEMENT AND PAVEMENT SECTIONS.
- 6. ALL DISTURBED AREAS THAT ARE NOT DESIGNATED TO BE PAVED SHALL BE LANDSCAPED OR SEEDED, ACCORDING TO THE LANDSCAPE PLAN.
- 7. EXISTING DRAINAGE STRUCTURES SHALL BE INSPECTED AND REPAIRED AS NEEDED, AND EXISTING PIPES CLEANED OUT TO REMOVE ALL SILT AND DEBRIS.
- 8. IF ANY EXISTING STRUCTURES, SIDEWALK, AND/OR CURB AND GUTTER, MODIFIED OR REMAINING, ARE DAMAGED DURING CONSTRUCTION, IT SHALL BE THE CONTRACTOR'S RESPONSIBILITY TO REPAIR AND/OR REPLACE THE EXISTING STRUCTURE AS NECESSARY TO RETURN IT TO EXISTING CONDITIONS OR BETTER PRIOR TO PROJECT CLOSEOUT.
- 9. NO PROPOSED SLOPE IN LANDSCAPED AREAS OR OPEN SPACE SHALL EXCEED THREE (3) HORIZONTAL FEET TO ONE (1) VERTICAL FOOT, OR AS OTHERWISE SPECIFIED BY LOCAL CRITERIA.
- 10. THE CONTRACTOR SHALL FILL AND COMPACT BASEMENTS, CESSPOOLS, AND OTHER LARGE EXCAVATED AREAS WITH CLEAN FILL SUITABLE TO THE OWNER, AND IN ACCORDANCE WITH RECOMMENDATIONS OBTAINED FROM THE GEOTECHNICAL INVESTIGATION OR GEOTECHNICAL ENGINEER AND GRADE TO MATCH EXISTING OR PROPOSED FINISH GRADE; OR CONFIRM SUCH WORK HAS BEEN PERFORMED PRIOR TO CONSTRUCTION.

### **BENCHMARKS**

ELEVATIONS ARE BASED UPON A POST-PROCESSED STATIC GNSS CONNECTION MADE TO NGS BENCH MARK E 392 (PID KK1298), BEING A STAINLESS ROD IN ACCESS COVER STAMPED E 392 1983 UTILIZING GEOID 12B TO MODEL THE ELLIPSOID SEPARATTION.

NGS ELEVATION: 5133.10 (NAVD 88).

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GRADIN


KG PROJECT TEAM: EES SDM: DG

CPM: BS

160

REVISION DESCRIPTION	INITIAL SUBMITTAL					REVISIONS	
DATE	07/07/2022						
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DATE	DATE: 07-07-2022						

# DEVELOPMENT PLAN KUM & GO GAS AND C-STORE PART OF THE NORTHEAST QUARTER OF SECTION 6, TOWNSHIP 3 SOUTH, RANGE 67

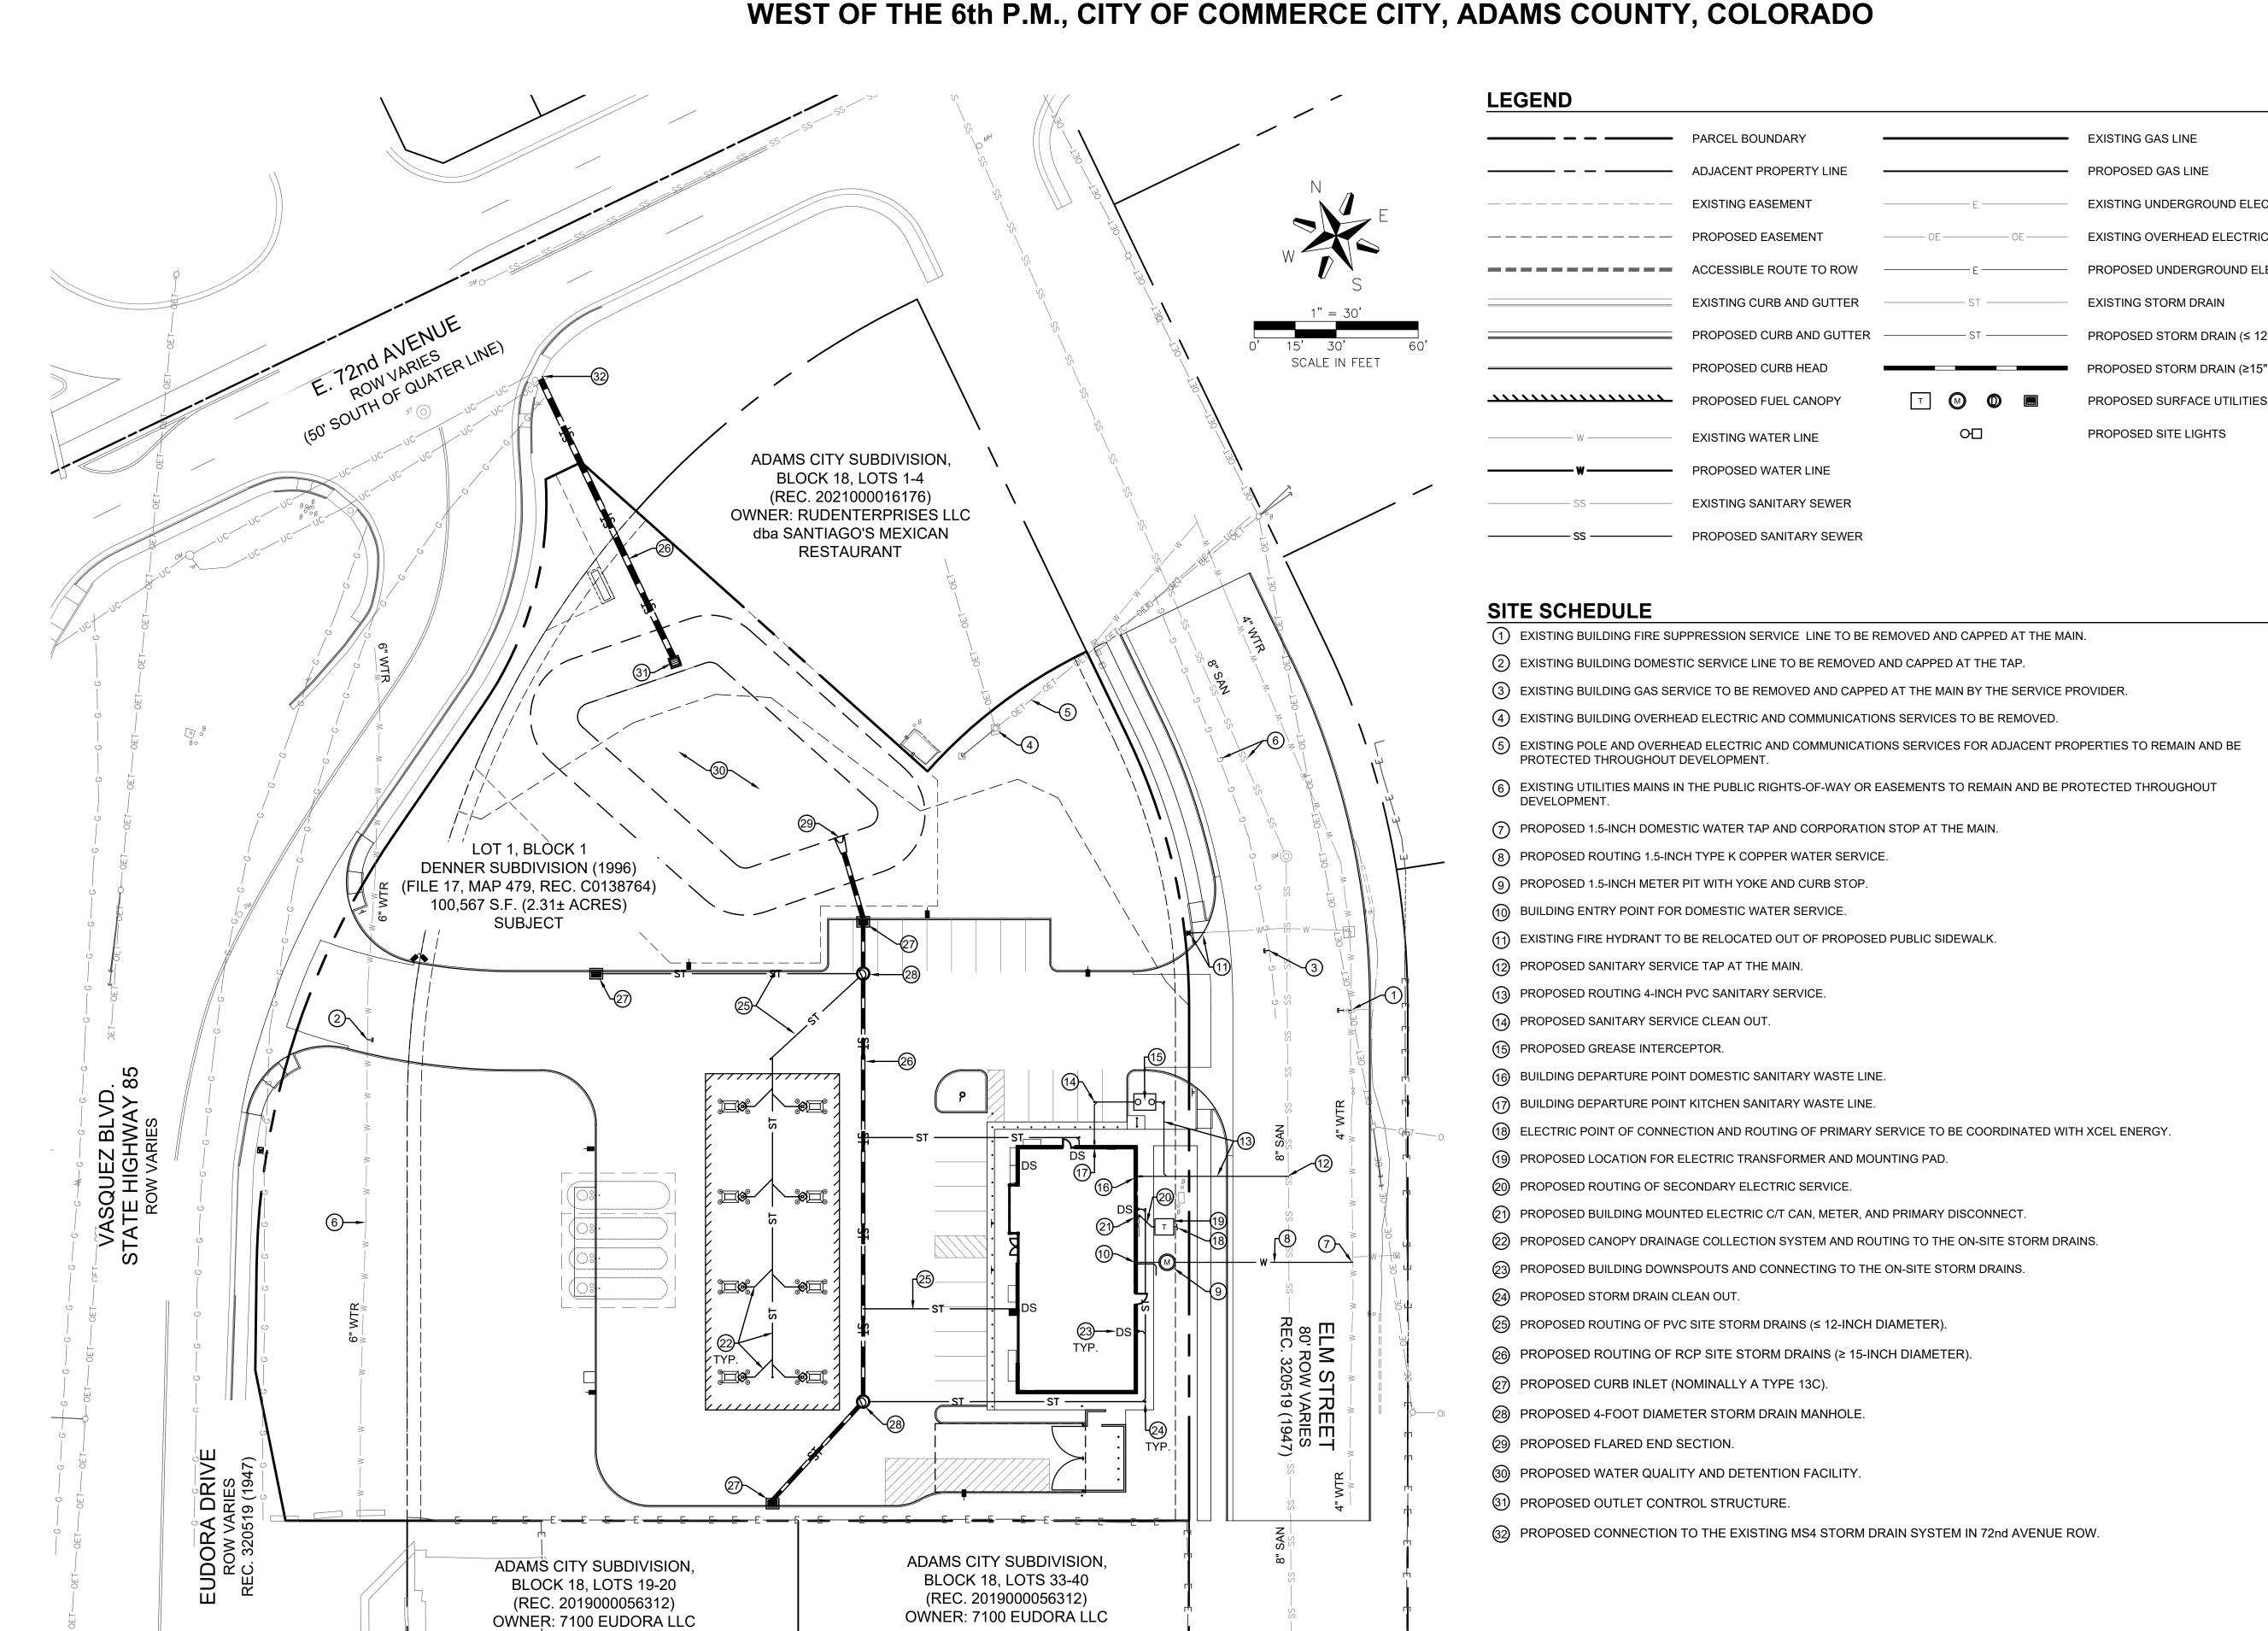





1459 Grand Ave Des Moines, IA 50309 P: 888-458-6646

> A DRIVE, COMMERCE CITY, CC SEVELOPMENT PLAN

KG PROJECT TEAM: EES RDM: RF SDM: DG CPM: BS

7160

DATE REVISION DESCRIPTION

07/07/2022 INITIAL SUBMITTAL

REVISIONS


DATE: 07-07-2022

SHEET NUMBER:

P3.0 4 OF 12

# DEVELOPMENT PLAN KUM & GO GAS AND C-STORE

PART OF THE NORTHEAST QUARTER OF SECTION 6, TOWNSHIP 3 SOUTH, RANGE 67 WEST OF THE 6th P.M., CITY OF COMMERCE CITY, ADAMS COUNTY, COLORADO

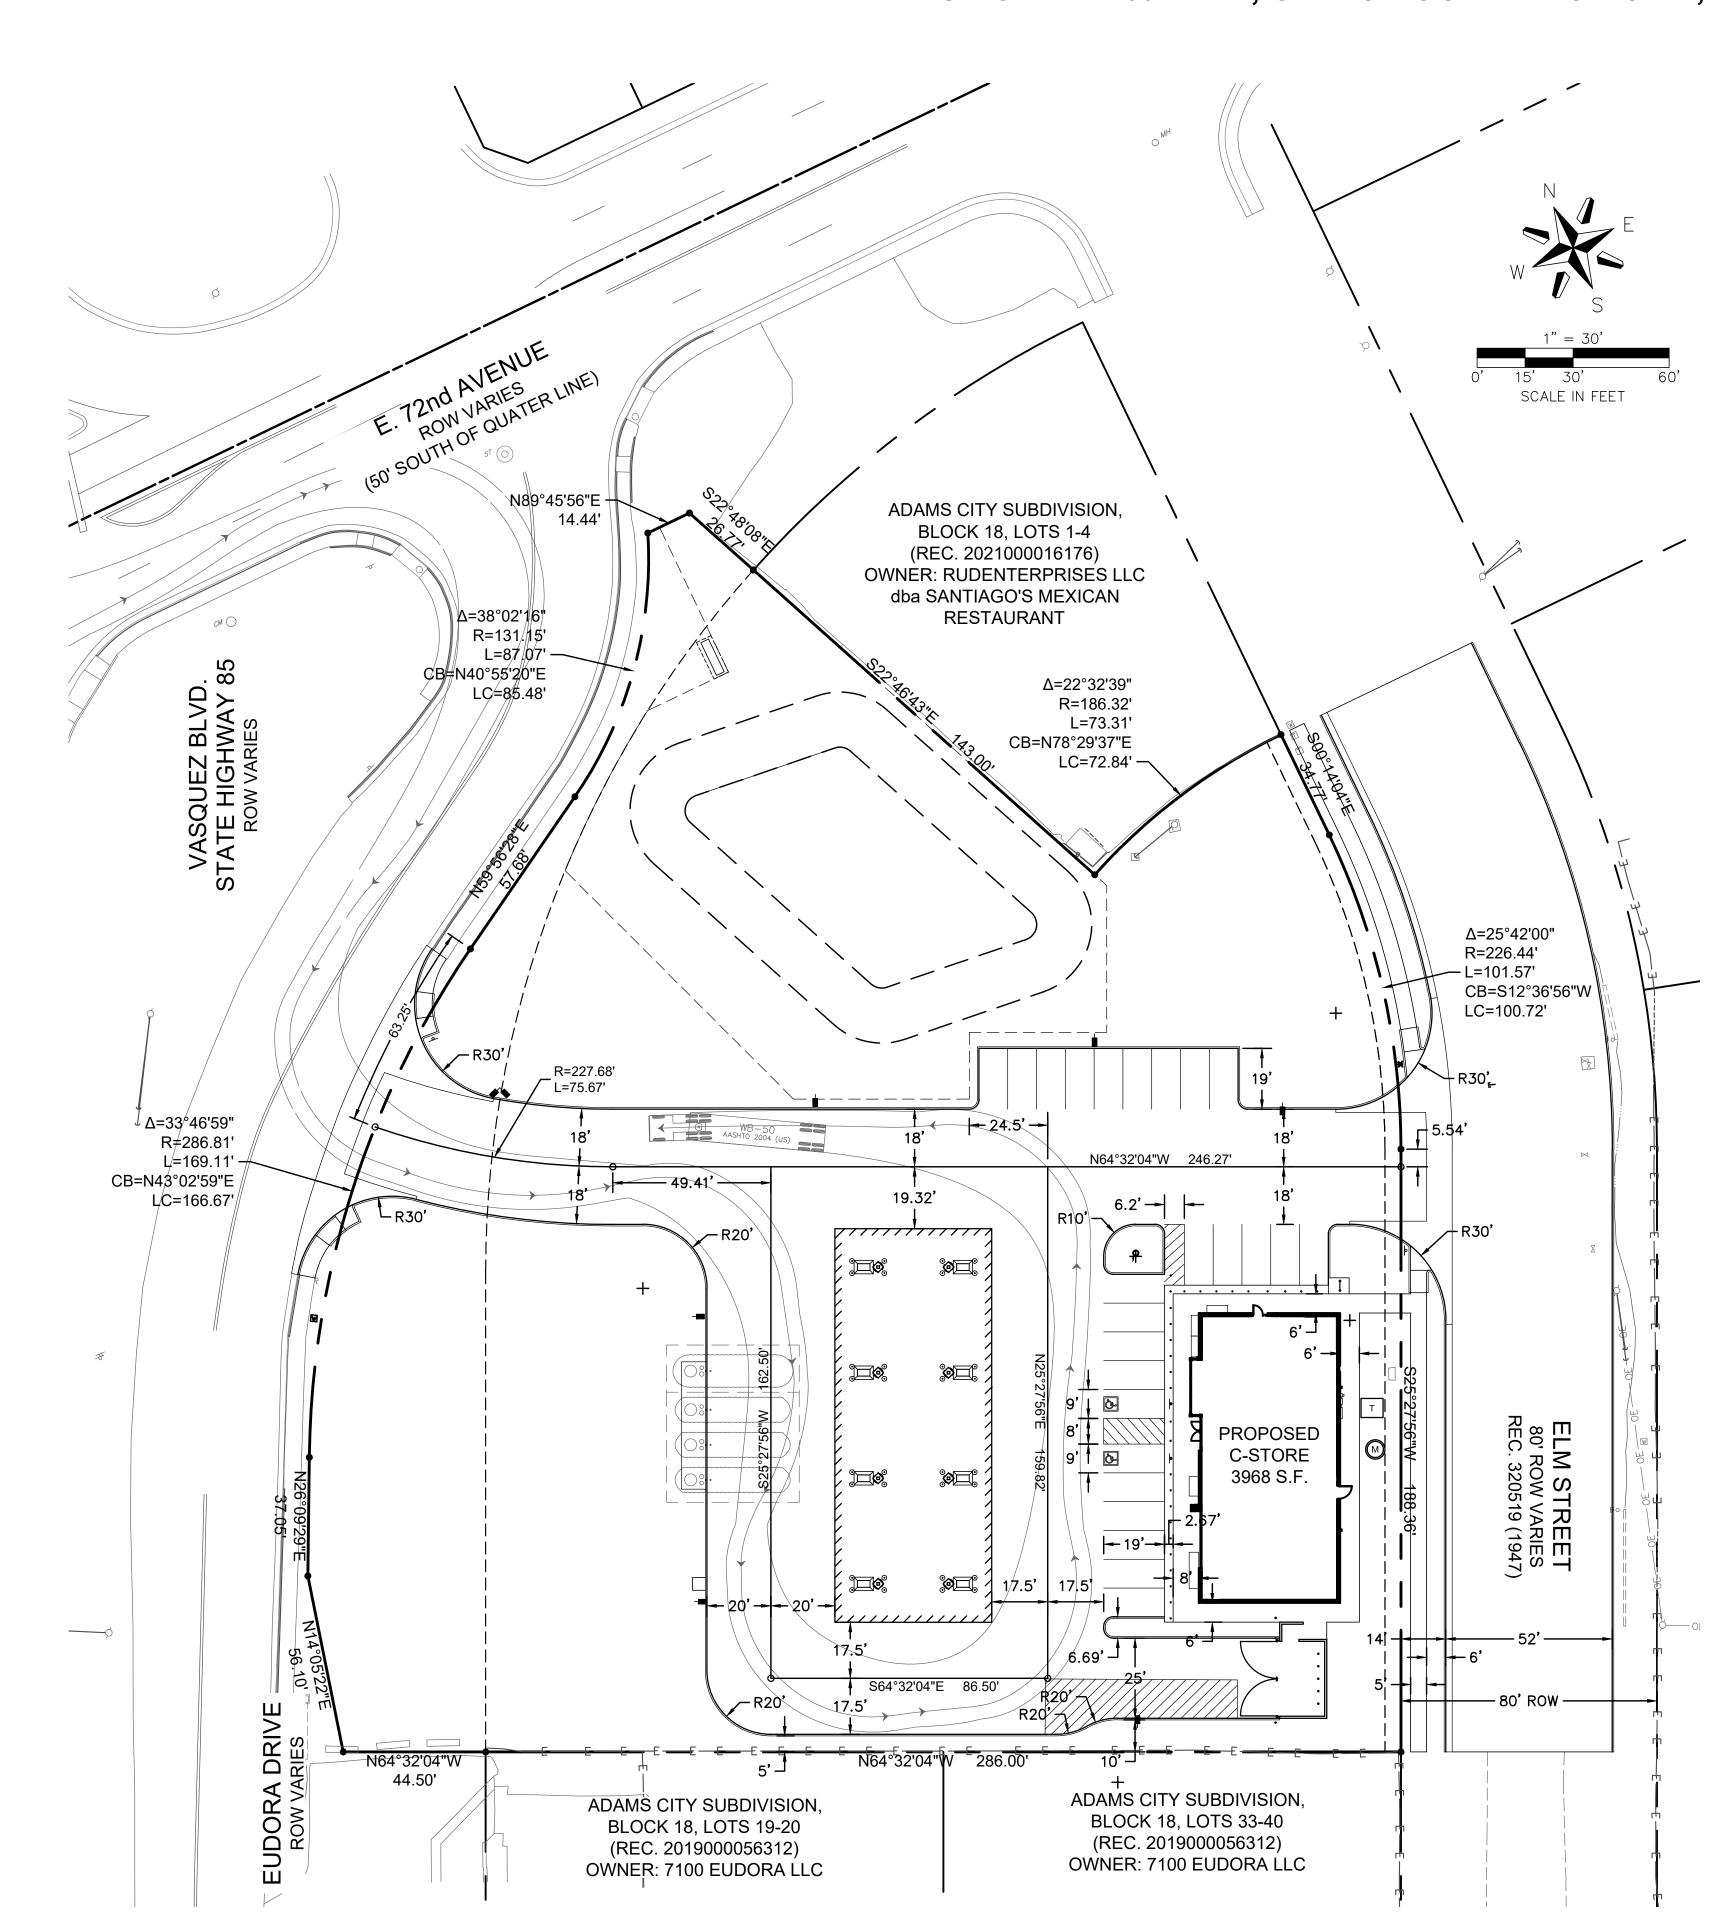

# PARCEL BOUNDARY ADJACENT PROPERTY LINE EXISTING EASEMENT PROPOSED EASEMENT ACCESSIBLE ROUTE TO ROW EXISTING CURB AND GUTTER PROPOSED CURB AND GUTTER PROPOSED CURB HEAD PROPOSED FUEL CANOPY LIMITS PROPERTY CORNER

### **GENERAL NOTES**

1. REFER TO THE COVER SHEET, SHEET 1, FOR ADDITIONAL PROJECT NOTES.

SITE METES/BOUNDS CONTROL

- 2. RADII NOT NOTED OTHERWISE ARE A 3-FOOT DIMENSION.
- 3. PROVIDE JOINTS AT 30 X DEPTH OF CONCRETE MAXIMUM SPACING IN VEHICULAR AREAS UNLESS OTHERWISE INDICATED. JOINTS SHALL EXTEND THROUGH THE ADJACENT CURB HEAD.
- 4. JOINT SPACING IN PEDESTRIAN AREAS (I.E. SIDEWALKS AND PATIOS) SHALL CREATE SQUARES TO THE GREATEST EXTENT PRACTICAL, BUT SIDES SHOULD NOT EXCEED 8-FEET IN LENGTH. CONTRACTION JOINTS THEREIN SHALL BE TOOL FINISHED.
- 5. PANELS FOR VEHICULAR PAVEMENT AND IN PEDESTRIAN AREAS SHALL HAVE A MAXIMUM LENGTH TO WIDTH RATIO OF 1.25:1.
- 6. BOND BREAKER SHALL BE USED AT INLETS, MANHOLES, AND SIMILAR SIZE STRUCTURES. SMALLER STRUCTURES SUCH AS VALVE COVERS AND MONUMENT BOXES SHALL NOT REQUIRE A BOND BREAKER, UNLESS SPECIFIED OTHERWISE.
- PROVIDE A CONTINUOUS ISOLATION JOINT AT THE BUILDING FOUNDATION. REFERENCE ARCHITECTURAL PLANS FOR ADDITIONAL INFORMATION.
- WHERE SLABS OF DIFFERENT THICKNESS COME TOGETHER, THE SUBGRADES UNDER THE THINNER PAVEMENTS SHOULD BE SHAPED TO PROVIDE GRADUAL PAVEMENT THICKNESS TRANSITION OVER A DISTANCE OF 3-FEET OR MORE.
- 9. ADJUST SPACING TO AVOID SMALL PANELS OR ANGLES (E.G. PANELS <1-FOOT AND ANGLES <60°; 90° PREFERRED).

### LEGAL DESCRIPTION

DESCRIPTION RECITED IN SPECIAL WARRANTY DEED RECORDED OCTOBER 31, 2018 AT RECEPTION No. 2018000088032;

LOT 1, BLOCK 1, DENNER SUBDIVISION,

AND THAT PART OF VACATED EUDORA DRIVE VACATED BY ORDINANCE No. V-60-96 RECORDED NOVEMBER 5, 1996 IN BOOK 4874 AT PAGE 289 AND RECORDED JUNE 9, 1997 IN BOOK 5026 AT PAGE 30,

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Des Moines, IA 50309 P: 888-458-6646

CUM & GO GAS AND C-STORE
EUDORA DRIVE, COMMERCE CITY, CC
DEVELOPMENT PLAN
DIMENSIONING PLAN

KG PROJECT TEAM: EES RDM: RF

SDM: DG


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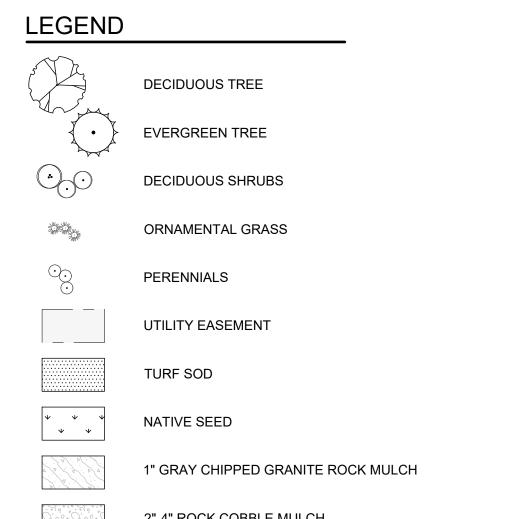
DATE	REVISION DESCRIPTION
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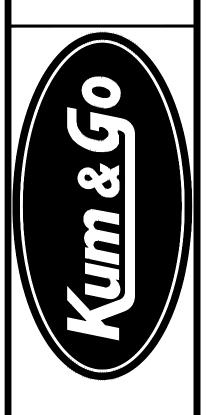
P4.0 5 OF 12

### **DEVELOPMENT PLAN KUM & GO GAS AND C-STORE** PART OF THE NORTHEAST QUARTER OF SECTION 6, TOWNSHIP 3 SOUTH, RANGE 67 WEST OF THE 6th P.M., CITY OF COMMERCE CITY, ADAMS COUNTY, COLORADO







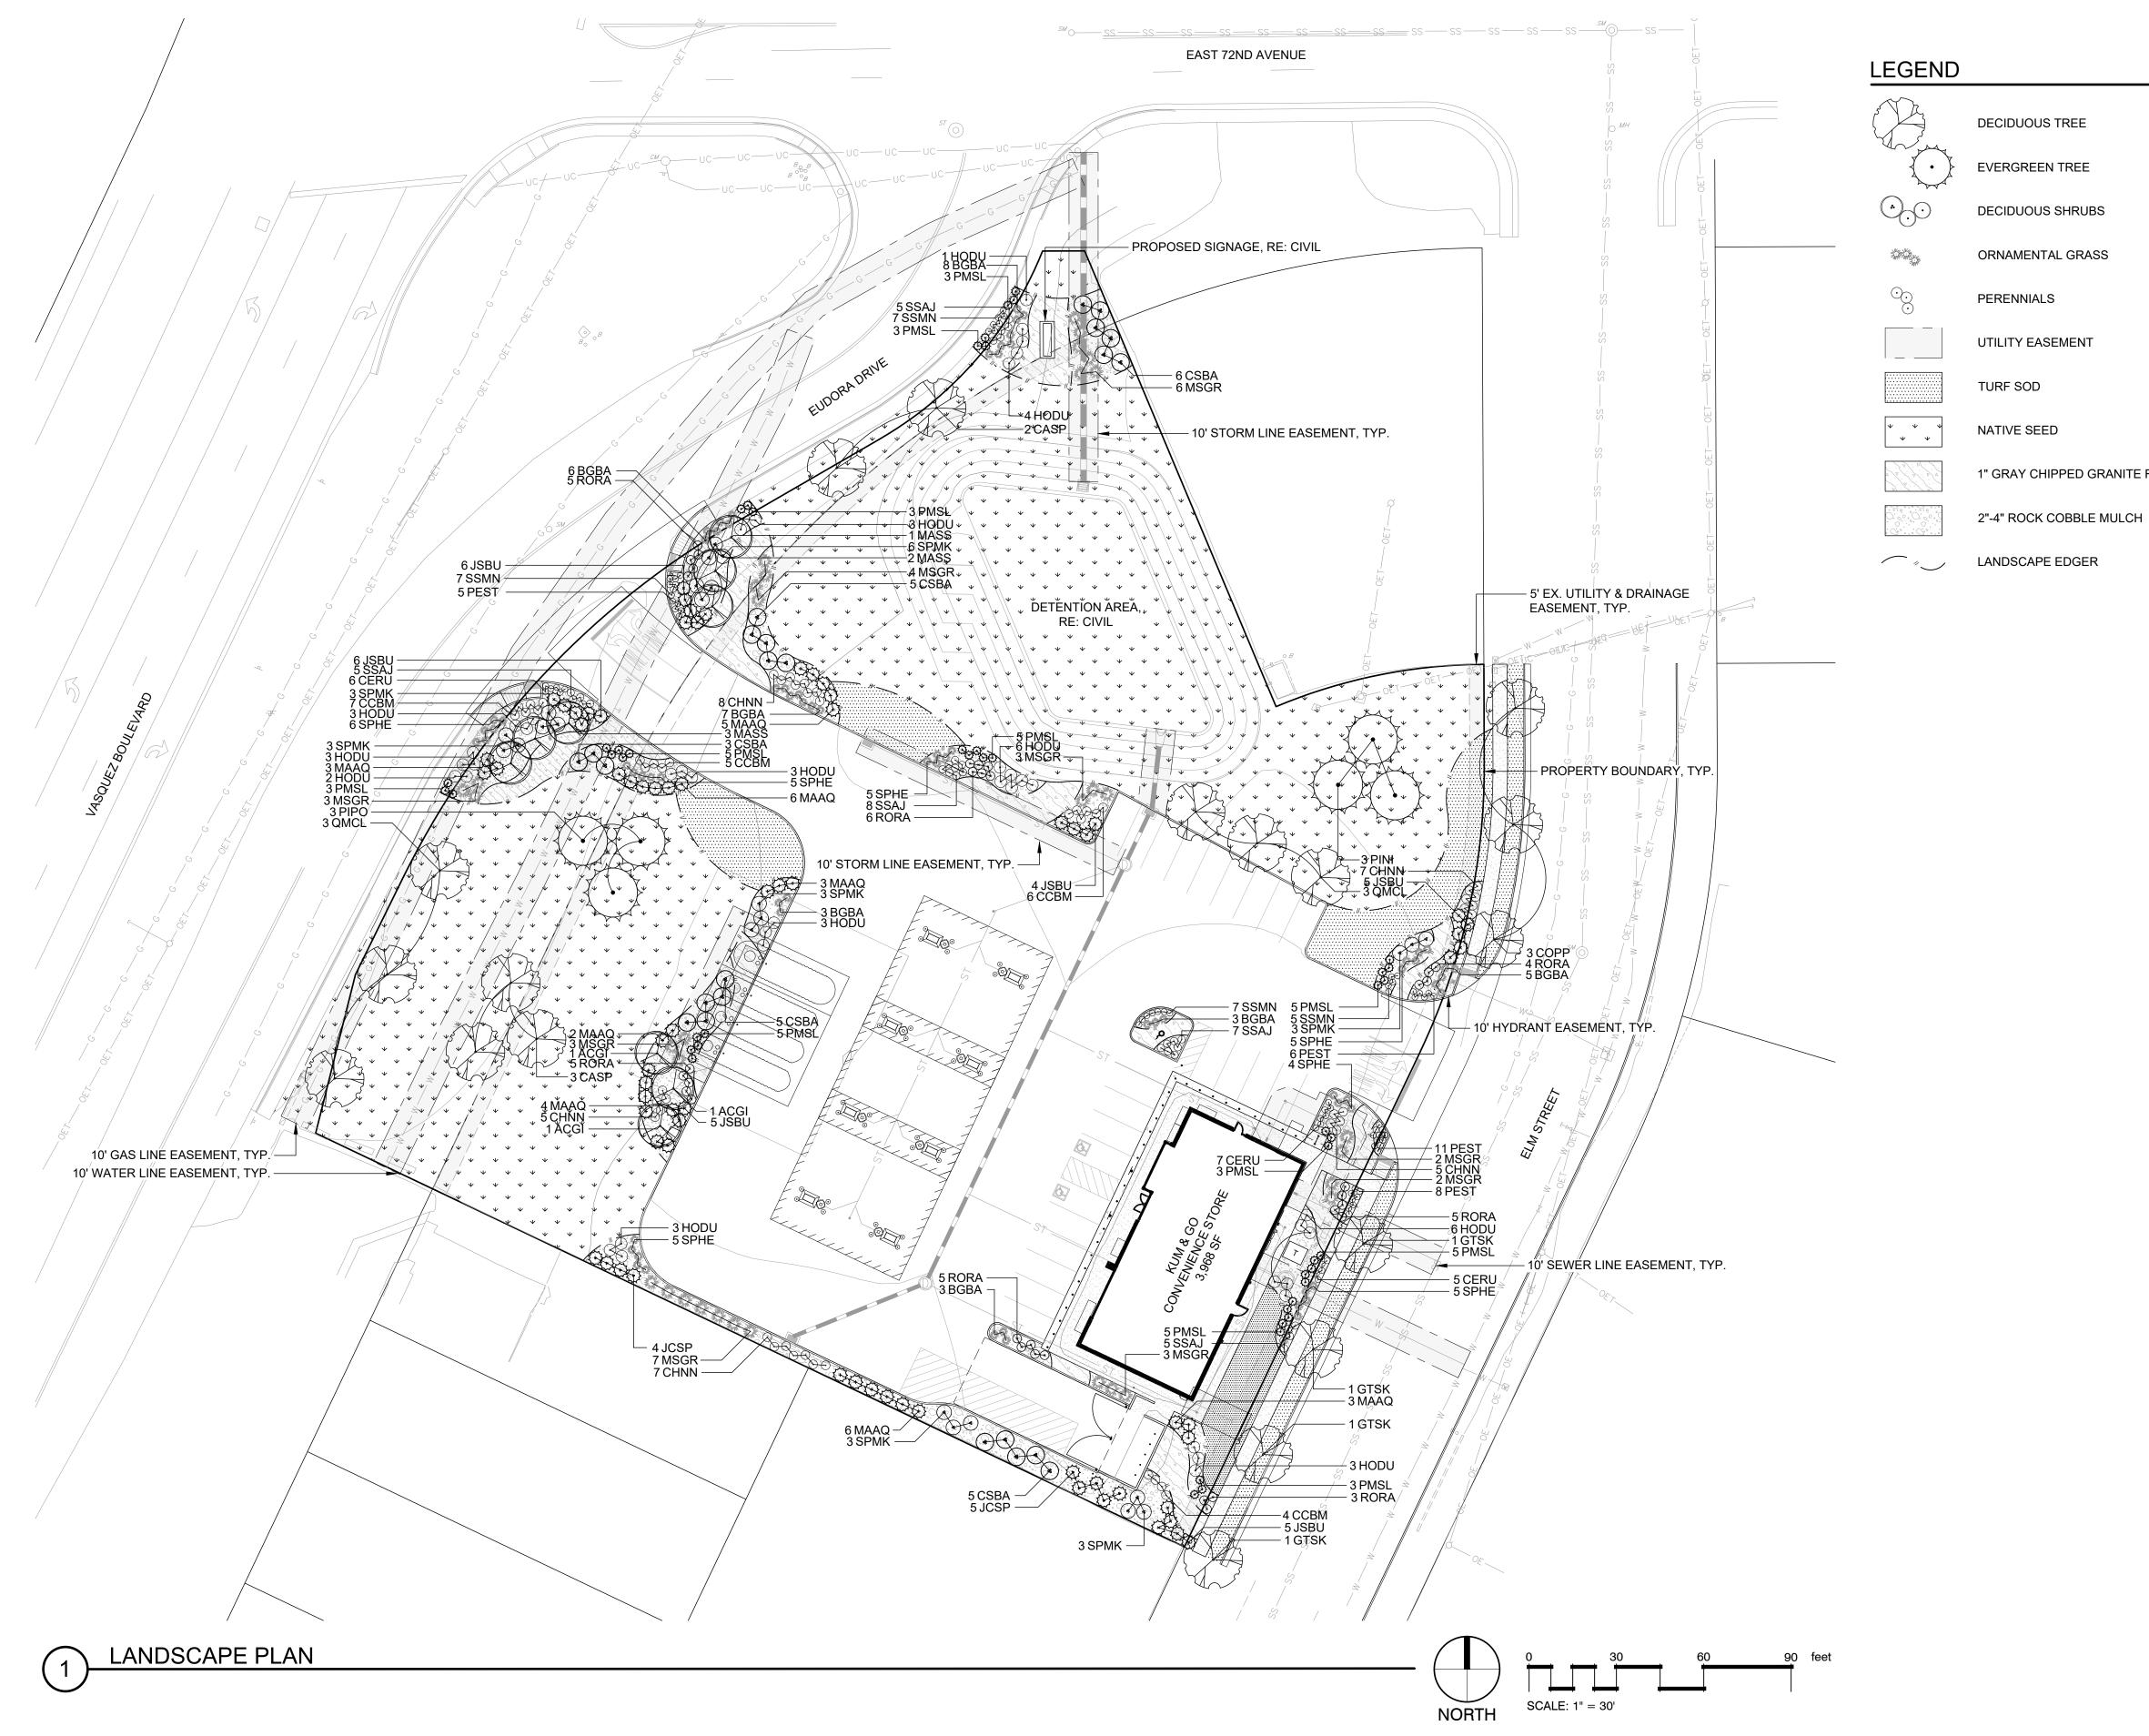

Des Moines, IA 50309 P: 888-458-6646

KUM & GO GAS AND C-STORI 7160 EUDORA DRIVE, COMMERCE CIT

KG P RDM: SDM: CPM:	RF DG	CT T	EAM:	EES		
REVISION DESCRIPTION						REVISIONS
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### **DEVELOPMENT PLAN KUM & GO GAS AND C-STORE**

### PART OF THE NORTHEAST QUARTER OF SECTION 6, TOWNSHIP 3 SOUTH, RANGE 67 WEST OF THE 6th P.M., CITY OF COMMERCE CITY, ADAMS COUNTY, COLORADO

### **GENERAL NOTES:**

- VERIFY ALL EXISTING CONDITIONS PRIOR TO BEGINNING WORK. BE AWARE OF ANY UNDERGROUND UTILITIES. PROTECT ALL EXISTING SITE FEATURES TO REMAIN FROM POTENTIAL DAMAGE BY SITE CONSTRUCTION OPERATIONS. AVOID ANY WORK BEYOND SCOPE OF PROJECT AREA.
- COORDINATE ALL DISCIPLINES AND SITE CONSTRUCTION THAT WILL BE NEEDED TO COMPLETE THE PROJECT IN THE TIME FRAME GIVEN AND WITHIN BUDGET. ALL ACCESS TO SITE, USE OF UTILITIES, STORAGE AND OTHER REQUIREMENTS SHALL BE COORDINATED PRIOR TO BEGINNING WORK.
- CONTRACTOR IS RESPONSIBLE TO INSPECT AND CONFIRM SITE CONDITIONS PRIOR TO BEGINNING WORK. COMMENCEMENT OF WORK SHALL SIGNIFY ALL CONDITIONS ARE ACCEPTABLE AND NO ALLOWANCE WILL BE MADE FOR UNRECOGNIZED CONDITIONS AFTER START OF WORK.
- 4. NOTIFY OWNER/LANDSCAPE ARCHITECT IMMEDIATELY UPON DISCOVERY OF UNFORESEEN SITE CONDITIONS OR PLAN DISCREPANCIES. NO CHANGE TO SPECIFIED WORK SHALL BE COMPLETED WITHOUT VERIFICATION OF EXISTING CONDITIONS AND WRITTEN APPROVAL OF MODIFICATION BY THE LANDSCAPE ARCHITECT.

### **CLEARING & GRADING:**

- 1. ALL CONSTRUCTION MUST BE IN ACCORDANCE WITH ALL APPLICABLE MUNICIPAL CODES AND DEVELOPMENT STANDARDS; UNIFORM BUILDING CODES; PERMIT CONDITIONS; AND ALL OTHER APPLICABLE CODES,
- ORDINANCES, STANDARDS, AND POLICIES. A COPY OF THE APPROVED PLANS MUST BE ON-SITE WHENEVER CONSTRUCTION IS IN PROGRESS.
- THE CONTRACTOR IS RESPONSIBLE FOR OBTAINING ANY OTHER RELATED OR REQUIRED PERMITS PRIOR TO BEGINNING CONSTRUCTION.
- 4. ALL LOCATIONS OF EXISTING UTILITIES HAVE BEEN ESTABLISHED BY FIELD SURVEY OR OBTAINED FROM AVAILABLE RECORDS AND SHOULD, THEREFORE, BE CONSIDERED APPROXIMATE ONLY AND NOT NECESSARILY COMPLETE. IT IS THE SOLE RESPONSIBILITY OF THE CONTRACTOR (1) TO INDEPENDENTLY VERIFY THE ACCURACY OF ALL UTILITY LOCATIONS AND (2) TO DISCOVER AND AVOID ANY OTHER UTILITIES NOT SHOWN WHICH MAY BE AFFECTED BY THE IMPLEMENTATION OF THIS PLAN.

### SOIL SPECIFICATIONS:

- ANY PLANTING AREA THAT DOES NOT MEET THE FOLLOWING SOIL PREPARATION REQUIREMENTS ARE SUBJECT TO REJECTION AT OWNER/OWNERS REPRESENTATIVES DISCRETION.
- LANDSCAPE CONTRACTOR IS REQUIRED TO NOTIFY OWNER/OWNERS REPRESENTATIVE A MINIMUM OF 24 HOURS PRIOR TO BEGINNING SOIL PREP WORK. SOIL PREP NOT INSPECTED BY OWNER/OWNERS
- REPRESENTATIVE IS SUBJECT TO REJECTION AT ANYTIME PRIOR TO INITIAL ACCEPTANCE. 3. LANDSCAPE CONTRACTOR SHALL SUBMIT DELIVERY (TRIP) TICKETS TO OWNER/OWNERS REPRESENTATIVE FOR ALL ORGANIC SOIL AMENDMENTS WITHIN 24 HOURS AFTER DELIVERY
- 4. IMPORTED TOPSOIL SHALL BE FERTILE, FRIABLE, SANDY LOAM FROM THE 'A' HORIZON AND SHALL BE FREE OF STONES OVER .75" IN DIAMETER, REFUSE, PLANTS OR THEIR ROOTS, STICKS, NOXIOUS WEEDS, SALTS, SOIL STERILANTS, OR OTHER MATERIAL WHICH WOULD BE DETRIMENTAL TO PLANT GROWTH.
- 5. ORGANIC SOIL AMENDMENT SHALL CONSIST OF DRY, WELL-ROTTED, PULVERIZED, AGED MINIMUM ONE YEAR ORGANIC COMPOST CLASS I TYPE SUCH AS AVAILABLE FROM A-1 COMPOST, JENSEN SALES. PULVERIZED HORSE, SHEEP OR DAIRY COW MANURE NOT ACCEPTABLE. SUBMIT DATED RECENT MATERIAL ANALYSIS TO OWNER/OWNERS REPRESENTATIVE TO GUARANTEE PRODUCT CONDITION AND PROOF
- NO LIVE WEED SEEDS AND CHEMICAL ADDITIVES ARE PRESENT 6. SOIL PREPARATION FOR AREAS TO BE SODDED SHALL INCLUDE TOPSOIL AND ORGANIC MATTER ADDED AT A RATE OF FIVE CUBIC YARDS PER ONE THOUSAND SQUARE FEET AND TILLED EIGHT (8) INCHES INTO
- 7. PREPARED BACKFILL FOR TREE/SHRUB PLANTING SHALL BE A MIX OF 2/3 IMPORTED/ SALVAGED TOPSOIL AND 1/3 ORGANIC SOIL AMENDMENT. WHERE TREES AND SHRUBS ARE LOCATED IN LARGE BEDS PROVIDE SOIL AMENDMENT AT A RATE OF FIVE CUBIC YARDS PER ONE THOUSAND SQUARE FEET AND TILL EIGHT INCHES INTO THE SOIL THROUGHOUT THE ENTIRE PLANTING BED, NOT JUST IN EXCAVATED PLANTING HOLES.

### **EDGING**:

1. ALL EDGING SHALL BE 1/8" X 4" GREEN PAINTED "RYERSON TYPE" METAL EDGING W/ MILLED EDGE AND ANCHOR STAKES PER MANUFACTURE'S SPECIFICATIONS OR EQUAL

### MULCH

- 1. PLANTING BEDS (AS SPECIFIED) SHALL CONTAIN 2"-4" RIVER ROCK COBBLE MULCH OVER FABRIC AT A MINIMUM DEPTH OF 3" WITH A DOUBLE SHREDDED CEDAR MULCH RING AROUND EACH TREE, SHRUB, GRASS, AND PERENNIAL. WOOD MULCH RING SHALL BE 1.5X THE CONTAINER SIZE OF THE SHRUB, GRASS OR PERENNIAL. TREE MULCH RING SHALL BE GREEN INDUSTRY STANDARD SIZE.
- 2. PLANTING BEDS (AS SPECIFIED) SHALL CONTAIN 1" GRAY CHIPPED GRANITE MULCH AT A MINIMUM DEPTH OF 3", DEPRESSED 2" BELOW SURROUNDING CURBS AND WALKS. PLACE WITH TIGHT JOINTS.
- 3. GEOTEXTILE FABRIC (FILTER FABRIC) UNDERLAYMENT SHALL BE MIRAFI, MIRASCAPE, DUPONT TYPAR 3301 OR APPROVED EQUAL (SUBMIT SAMPLE).

### PLANT SCHEDULE

DECIDUOUS TREES CASP COPP GTSK QMCL	QTY 5 3 4 6	BOTANICAL NAME CATALPA SPECIOSA CELTIS OCCIDENTALIS 'PRAIRIE PRIDE' GLEDITSIA TRIACANTHOS INERMIS 'SKYLINE' QUERCUS X MACDANIELII 'CLEMONS'	COMMON NAME NORTHERN CATALPA PRAIRIE PRIDE HACKBERRY SKYLINE HONEY LOCUST HERITAGE OAK	CONT B & B B & B B & B B & B	<u>CAL</u> 2"CAL 2"CAL 2"CAL 2"CAL
EVERGREEN TREES PINI PIPO	QTY 3 3	BOTANICAL NAME PINUS NIGRA PINUS PONDEROSA	COMMON NAME AUSTRIAN PINE PONDEROSA PINE	CONT B & B B & B	<u>CAL</u> 6` HT 6` HT
ORNAMENTAL TREES ACGI MASS	QTY 3 6	BOTANICAL NAME ACER GINNALA MALUS X 'SPRING SNOW'	COMMON NAME AMUR MAPLE SPRING SNOW CRABAPPLE	CONT B & B B & B	<u>CAL</u> 1.5"CAL 1.5"CAL
DECIDUOUS SHRUBS CCBM CHNN CSBA HODU RORA SPMK	QTY 22 32 24 40 33 24	BOTANICAL NAME CARYOPTERIS X CLANDONENSIS 'BLUE MIST' CHRYSOTHAMNUS NAUSEOSUS NAUSEOSUS CORNUS SERICEA 'BAILEYI' HOLODISCUS DUMOSUS ROSA X 'RADRAZZ' SYRINGA PATULA 'MISS KIM'	COMMON NAME BLUE MIST SPIREA DWARF BLUE RABBITBRUSH RED TWIG DOGWOOD ROCK SPIREA KNOCK OUT ROSE MISS KIM KOREAN LILAC	CONT #5 #5 #5 #5 #5 #5	
EVERGREEN SHRUBS JCSP JSBU MAAQ PMSL	QTY 9 31 32 48	BOTANICAL NAME JUNIPERUS CHINENSIS 'SPARTAN' JUNIPERUS SABINA 'BUFFALO' MAHONIA AQUIFOLIUM PINUS MUGO 'SLOWMOUND'	COMMON NAME SPARTAN JUNIPER BUFFALO JUNIPER OREGON GRAPE SLOWMOUND MUGO PINE	<u>CONT</u> #5 #5 #5 #5	
ORNAMENTAL GRASSES BGBA MSGR SPHE	QTY 35 33 35	BOTANICAL NAME BOUTELOUA GRACILIS 'BLONDE AMBITION' MISCANTHUS SINENSIS 'GRACILLIMUS' SPOROBOLUS HETEROLEPIS	COMMON NAME BLONDE AMBITION BLUE GRAMA MAIDEN GRASS PRAIRIE DROPSEED	CONT #1 #1 #1	
PERENNIALS CERU PEST SSMN SSAJ	QTY 18 30 26 30	BOTANICAL NAME CENTRANTHUS RUBER PENSTEMON STRICTUS SALVIA X SYLVESTRIS 'MAY NIGHT' SEDUM SPECTABILE 'AUTUMN JOY'	COMMON NAME RED VALERIAN ROCKY MOUNTAIN PENSTEMON MAY NIGHT SAGE AUTUMN JOY STONECROP	CONT #1 #1 #1 #1	
GROUND COVERS	<u>QTY</u>	BOTANICAL NAME	COMMON NAME	CONT @	
\( \psi \)	40,712 SF		NATIVE SEED	SEED	
	5,575 SF	NATURE'S PRAIRIE SOD	SOD	SOD	

### **PLANTING NOTES:**


- 1. LANDSCAPE CONTRACTOR SHALL LOCATE ALL TREES, SHRUBS AND PLANTING BEDS ACCORDING TO LOCATIONS SHOWN ON DRAWINGS. ALL PLANTING LOCATIONS SHALL BE SUBJECT TO REVIEW AND APPROVAL BY LANDSCAPE ARCHITECT PRIOR TO THE START OF PLANTING OPERATIONS. LANDSCAPE CONTRACTOR SHALL MAKE MODIFICATIONS IN LOCATIONS AS DIRECTED BY LANDSCAPE ARCHITECT. THE PLANT SCHEDULE IS FOR CONTRACTOR'S CONVENIENCE ONLY, THE CONTRACTOR SHALL BE RESPONSIBLE FOR VERIFYING EXISTING CONDITIONS AND REPORTING IN WRITING TO THE LANDSCAPE
- ARCHITECT ANY CONFLICTS RELATIVE TO IMPLEMENTATION OF THE LANDSCAPE CONSTRUCTION DOCUMENTS. VALERIAN LLC. SHALL NOT ASSUME ANY ERRORS OR OMISSIONS IN THE PLANT SCHEDULE LISTED HEREIN. THE PLANT SYMBOLS SHOWN ON THE LANDSCAPE PLAN SHALL PREVAIL SHOULD THERE BE ANY DISCREPANCIES IN QUANTITIES BETWEEN THE PLAN AND PLANT SCHEDULE.
- LANDSCAPE CONTRACTOR SHALL PROVIDE PLANT PROTECTION AND MAINTENANCE THROUGHOUT INSTALLATION AND UNTIL FINAL ACCEPTANCE OF LANDSCAPE INSTALLATION AS FOLLOWS: A) ALL PLANT MATERIAL SHALL BE PROTECTED, FROM TIME OF DIGGING TO TIME OF FINAL ACCEPTANCE, FROM INJURY, EXCESSIVE DRYING FROM WINDS, IMPROPER VENTILATION, OVER-WATERING,
- FREEZING, HIGH TEMPERATURES, OR ANY OTHER CONDITION DAMAGING TO PLANTS. B) PLANT MATERIAL SHALL BE PLANTED ON THE DAY OF DELIVERY IF POSSIBLE. ALL PLANTS NOT PLANTED ON THE DAY OF DELIVERY SHALL BE PLACED IN A TEMPORARY NURSERY AND KEPT MOIST SHADED, AND PROTECTED FROM THE SUN AND WIND. EACH ROOTBALL SHALL BE COVERED ENTIRELY WITH MULCH. ALL PLANT MATERIALS SHALL BE INSTALLED PER THE PLAN DRAWINGS AND
- C) LANDSCAPE CONTRACTOR SHALL PROVIDE PLANT MATERIALS THAT COMPLY WITH THE REQUIREMENTS OF THE MOST RECENT ANSI Z 60.1 "STANDARDS FOR NURSERY STOCK" UNLESS OTHERWISE
- SPECIFIED. CALIPER OF B&B TREES SHALL BE TAKEN 6 INCHES ABOVE THE GROUND UP TO AND INCLUDING 4 INCH CALIPER SIZE, AND 12 INCHES ABOVE THE GROUND FOR LARGER SIZES. D) PLANTING MAINTENANCE SHALL INCLUDE WATERING, WEEDING, CULTIVATING, RESETTING PLANTS TO PROPER GRADES OR POSITION, REESTABLISHING SETTLED GRADES. HERBICIDE IS NOT RECOMMENDED FOR ONE YEAR FOLLOWING LANDSCAPE INSTALLATION.
- E) PLANT MAINTENANCE SHALL INCLUDE THOSE OPERATIONS NECESSARY TO PROPER GROWTH AND SURVIVAL OF ALL PLANT MATERIALS. CONTRACTOR SHALL PROVIDE THIS WORK IN ADDITION TO SPECIFIC WARRANTY/GUARANTEES.
- CONTRACTOR SHALL VERIFY AND MAINTAIN ALL SETBACKS, CLEAR ZONES AND SIGHT TRIANGLES REQUIRED BY ALL LOCAL AND MUNICIPAL CODES WHERE APPLICABLE LANDSCAPE CONTRACTOR SHALL ENSURE THAT THE LANDSCAPE INSTALLATION IS COORDINATED WITH THE PLANS PREPARED BY OTHER CONSULTANTS SO THAT THE PROPOSED GRADING. STORM
- DRAINAGE OR OTHER PROPOSED CONSTRUCTION DOES NOT CONFLICT WITH NOR PRECLUDE INSTALLATION AND MAINTENANCE OF LANDSCAPE ELEMENTS AS DESIGNATED ON THIS PLAN. ALL LANDSCAPE AREAS SHALL BE IRRIGATED BY AN AUTOMATIC UNDERGROUND IRRIGATION SYSTEM. THE SYSTEM SHALL BE PROPERLY ZONED TO SEPARATE PLANT MATERIAL BY WATER REQUIREMENT.

ALL SHRUB BEDS AND TREES IN NATIVE SEED AREAS SHALL BE IRRIGATED BY USING LOW WATER/DRIP TECHNIQUES. ALL TURF AREAS SHALL BE IRRIGATED USING POP-UP SPRAY OR ROTOR APPLICATION.

- KEEP ALL EQUIPMENT, VEHICLES AND FOOT TRAFFIC OFF ALL SODDED AREAS. ALL DAMAGED MATERIALS SHALL BE REPLACED AND ALL DAMAGED AREAS RESTORED TO ORIGINAL CONDITIONS. ALL SOD SHALL BE A TEXAS HYBRID SOD AS OUTLINED IN THE PLANT SCHEDULE OR APPROVED EQUAL. FOR SUBSTITUTION APPROVAL CONTACT THE OWNER'S REPRESENTATIVE OR LANDSCAPE
- ALL SOD SHALL BE INSTALLED WITHIN 24 HOURS FROM THE TIME OF CUTTING ON A FIRM AND MOIST SUBGRADE. DO NOT PLANT IF SOD IS DORMANT OR THE GROUND IS FROZEN
- ALL SOD SHALL BE INSTALLED PARALLEL TO SLOPES TO FORM A SOLID MASS WITH TIGHTLY FITTED JOINTS. BUTT ENDS AND SIDES OF SOD STRIPS. DO NOT OVERLAP. STAGGER STRIPS TO OFFSET JOINTS

### **COMMERCE CITY NOTES:**

- REFERENCE THE COMMERCE CITY LANDSCAPE STANDARDS "FACTS TO KNOW" DOCUMENT FOR ALL LANDSCAPE STANDARDS AND SPECS. MINIMUM PLANT SIZE REQUIREMENTS AND SOIL PREPARATION: MINIMUM PLANT SIZE REQUIREMENTS ARE 2-INCH DIAMETER (CALIPER) FOR DECIDUOUS TREES, 1.5 INCH DIAMETER FOR ORNAMENTAL TREES AND 6' HEIGHT FOR EVERGREEN TREES, MINIMUM SIZE REQUIREMENTS FOR SHRUBS IS #5 GALLON CONTAINER: ORNAMENTAL GRASSES #1 GALLON CONTAINER: PERENNIALS AND GROUND COVERS 2-1" POTS. PLANTS SHOULD BE MIXED APPROXIMATELY 50% CONIFEROUS (EVERGREEN) AND 50% DECIDUOUS (TREE LAWN AREAS BETWEEN CURBS AND DETACHED WALKS SHALL BE ALL DECIDUOUS SHADE TREES). MINIMUM SOIL PREPARATION FOR PLANTING SHALL BE 5 CUBIC YARDS OF ORGANIC SOIL AMENDMENT TILLED TO A DEPTH OF 6 INCHES FOR EVERY 1.000 SF OF LANDSCAPE AREA.
- STREET TREES: THE PLANNING DIVISION HAS IDENTIFIED SPECIFIC DECIDUOUS TREE SPECIES TO BE PLANTED WITHIN TREE LAWN AREAS. ALL TREES CHOSEN FOR TREE LAWN APPLICATIONS MUST BE SELECTED FROM THE APPROVED PLANT LIST.
- WEED BARRIER: POROUS WEED FABRIC MUST BE USED IN PLANTED BEDS. PLASTIC WEED BARRIERS ARE PROHIBITED
- EDGING:PLASTIC OR FIBERGLASS EDGING IS FAVORABLE TO METAL. HOWEVER, METAL EDGING MAY BE USED PROVIDED IT HAS A ROLLOVER TOP OR A PROTECTIVE CAP IMPLEMENTATION AND COORDINATION OF THE LANDSCAPE PLAN: THE DEVELOPER SHALL ENSURE THAT THE LANDSCAPE PLAN IS CLOSELY COORDINATED WITH PLANS PREPARED BY OTHER CONSULTANTS SO THAT THE PROPOSED GRADING, STORM DRAINAGE, OR OTHER CONSTRUCTION DOES NOT CONFLICT WITH OR PRECLUDE THE INSTALLATION AND MAINTENANCE OF LANDSCAPE ELEMENTS AS
- DESIGNATED ON THE LANDSCAPE PLAN. IRRIGATION: ALL LANDSCAPE AREAS AND PLANT MATERIALS MUST BE WATERED BY AN AUTOMATIC UNDERGROUND IRRIGATION SYSTEM. IRRIGATION SYSTEM DESIGN, INSTALLATION, OPERATION, AND MAINTENANCE SHALL CONFORM TO THE REQUIREMENTS OF THE SOUTH ADAMS COUNTY WATER AND SANITATION DISTRICT (SACWSD). APPROVAL OF THIS LANDSCAPE PLAN DOES NOT CONSTITUTE APPROVAL FROM THE SACWSD.
- 8.1. THE DEVELOPER, HIS SUCCESSORS, AND ASSIGNS, SHALL BE RESPONSIBLE FOR INSTALLATION, MAINTENANCE AND REPLACEMENT OF ALL LANDSCAPING MATERIALS SHOWN OR INDICATED ON THE
- APPROVED LANDSCAPE PLAN, INCLUDING THE LANDSCAPING WITHIN THE RIGHT-OF-WAY. 8.2. LANDSCAPING SHALL BE CONTINUOUSLY MAINTAINED INCLUDING NECESSARY WATERING, WEEDING, PRUNING, PEST CONTROL, AND REPLACEMENT OF DEAD OR DISEASED PLANT MATERIAL SHALL BE OF THE SAME TYPE OF PLANT MATERIAL AS SET FORTH IN THE APPROVED SITE PLAN (A TREE MUST REPLACE A TREE OR A SHRUB MUST REPLACE A SHRUB). ANY REPLACEMENT SHALL OCCUR IN THE NEXT
- PLANTING SEASON, BUT IN NO CASE SHALL REPLACEMENT EXCEED 1 YEAR. 8.3. THIS APPROVED LANDSCAPE PLAN SHALL BE ON FILE IN THE PLANNING DIVISION. ALL LANDSCAPING WILL BE INSTALLED AS DELINEATED ON THE PLAN PRIOR TO THE ISSUANCE OF ANY CERTIFICATE OF
- 12. VEHICLE PARKING NOTE: NO VEHICLE PARKING IS ALLOWED IN ANY LANDSCAPE TREATMENT AREA. 13. SIGHT LINE CONSIDERATIONS: ANY AREA DETERMINED BY THE CITY ENGINEER TO BE WITHIN A SIGHT-DISTANCE-TRIANGLE MAY CONTAIN PLANT MATERIAL THAT. AT THE TIME OF PLANTING OR AT MATURITY. EXCEEDS 36 INCHES ABOVE THE GUTTER FLOW LINE EXCEPT TREES, WHICH MUST BE LIMBED TO 8 FEET AT ADEQUATE MATURITY. TREES SHALL BE PLANTED A MINIMUM OF 10 FEET FROM LIGHT OR UTILITY
- POLES. ALL OTHER LANDSCAPE FEATURES SHALL NOT EXCEED 36 INCHES IN HEIGHT WITHIN SIGHT DISTANCE-TRIANGLES. INFORMATION ON THE SIGHTDISTANCE-TRIANGLES MAY BE OBTAINED FROM THE 14. CITY OF COMMERCE CITY ENGINEERING STANDARDS.IMPLEMENTATION AND COORDINATION OF LANDSCAPE PLAN: THE DEVELOPER SHALL ENSURE THAT THE LANDSCAPE PLAN IS CLOSELY COORDINATED WITH PLANS PREPARED BY OTHER CONSULTANTS SO THAT THE PROPOSED GRADING, STORM DRAINAGE OR OTHER CONSTRUCTION DOES NOT CONFLICT WITH OR PRECLUDE THE INSTALLATION AND
- MAINTENANCE OF LANDSCAPE ELEMENTS AS DESIGNATED ON THE LANDSCAPE PLAN. 15. NATIVE GRASS NOTE: ALL AREAS OF THE LOT NOT PAVED OR FORMALLY LANDSCAPED, SHALL BE, AT A MINIMUM, SEEDED WITH NATIVE GRASSES

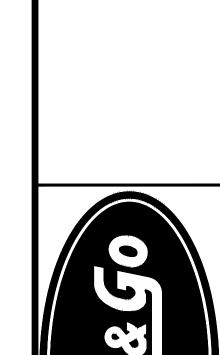



1459 Grand Ave Des Moines, IA 50309 P: 888-458-6646

AND C-STC

160

G PROJECT TEAM: EES RDM: RF BDM: DG CPM: BS						
REVISION DESCRIPTION						REVISIONS
DATE						




07-07-2022 SHEET NUMBER: L2.1

# I-102\_EES\_COMMERCE CITY - 72ND AND VASQUEZ K&G 2300\2-WORKING\2022-07-0.

# DEVELOPMENT PLAN KUM & GO GAS AND C-STORE

# PART OF THE NORTHEAST QUARTER OF SECTION 6, TOWNSHIP 3 SOUTH, RANGE 67 WEST OF THE 6th P.M., CITY OF COMMERCE CITY, ADAMS COUNTY, COLORADO

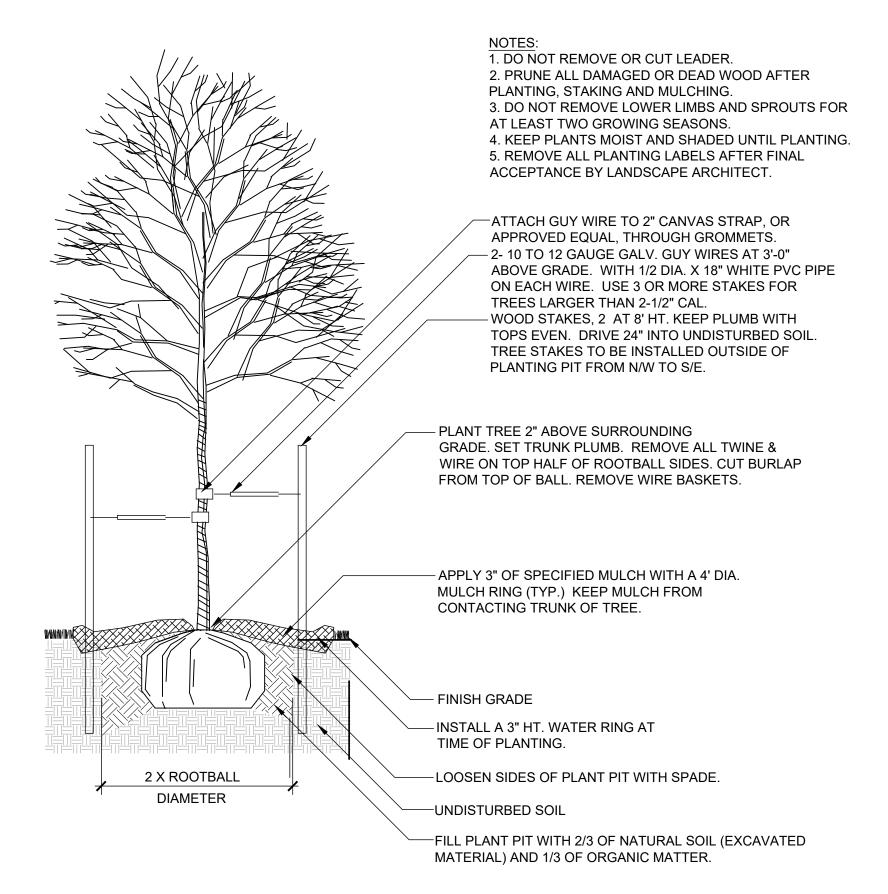

NOTE: ALL TREES LOCATED WITHIN SIGHT TRIANGLES OR WITHIN 100' APPROACHING A STOP SIGN ARE TO BE LIMBED TO 8'. AT ONSET OF WINTER FOR THE FIRST YEAR OF INSTALLATION, WRAP ENTIRE SURFACE OF TRUNK UP TO BRANCHES. SECURE AT TOP AND BOTTOM WITH DUCT TAPE. AT ONSET OF SPRING REMOVE ALL WRAPPING.

1 DECIDUOUS TREE PLANTING

ATTACH GUY WIRE TO 2" CANVAS STRAP, OR APPROVED EQUAL, THROUGH GROMMETS. WHITE PVC PIPE 36" LENGTH ON EACH WIRE. PLANT TREE 4" ABOVE SURROUNDING FINISH GRADE. SET TRUNK PLUMB. DO NOT PRUNE UP LOWER BRANCHES. APPLY 3" OF SPECIFIED MULCH WITH A 4' DIA. MULCH RING (TYP.) KEEP MULCH FROM CONTACTING INSTALL A 3" HT. WATER RING AT TIME OF PLANTING. - FINISH GRADE METAL STAKES, 3 PER TREE ALIGNED EQUALLY AROUND TREE. BURY ANCHOR UNDERGROUND. USE 'DUCK BILL' EARTH ANCHOR OR APPROVED EQUAL. - FILL PLANT PIT WITH 2/3 OF NATURAL SOIL (EXCAVATED MATERIAL) AND 1/3 OF ORGANIC - LOOSEN SIDES OF PLANT PIT WITH SPADE. 2 X ROOTBALL DIAMETER REMOVE ALL TWINE & WIRE ON TOP HALF OF ROOTBALL SIDES. CUT BURLAP FROM TOP OF BALL. REMOVE WIRE BASKETS.

- UNDISTURBED SOIL

BLCC-04

2. PRUNE ALL DAMAGED OR DEAD WOOD AFTER PLANTING, STAKING AND MULCHING.

3. DO NOT REMOVE LOWER LIMBS AND SPROUTS FOR AT LEAST TWO GROWING SEASONS.

5. REMOVE ALL PLANTING LABELS AFTER FINAL ACCEPTANCE BY LANDSCAPE ARCHITECT.

1. DO NOT REMOVE OR CUT LEADER.

4. KEEP PLANTS MOIST AND SHADED UNTIL PLANTING.

EVERGREEN TREE PLANTING

PRUNE ALL DAMAGED OR DEAD WOOD AFTER PLANTING AND MULCHING. REMOVE ALL PLANTING LABELS ONLY AFTER FINAL APPROVAL BY LANDSCAPE ARCHITECT.

SET SHRUB 1" HIGHER THAN GROWN IN NURSERY.

MULCH RING - APPLY 3" OF SPECIFIED WOOD MULCH

INSTALL WATER RING AT TIME OF PLANTING.

APPLY 3" OF SPECIFIED ROCK MULCH

FINISH GRADE

LOOSEN SIDES OF PLANT PIT. SCORE ROOTBALLS WITH ENCIRCLING ROOTS.

FILL PLANT PIT WITH 2/3 OF NATURAL SOIL (EXCAVATED MATERIAL) WITH 1/3 OF ORGANIC MATTER.

REMOVE ALL CONTAINER MATERIAL. PLACE OVER UNDISTURBED SOIL.

UNDISTURBED SOIL

NOTE: ANY PLANT NOT IN ACCORDANCE WITH COLORADO NURSERY ACT REQUIREMENTS WILL BE REJECTED. HOLD MULCH GRADE 1" BELOW EDGE OF WALK, EDGING AND CURB. JUNIPER PLANTS SHALL BE PLANTED WITH TOP OF ROOTBALL AT FINISH GRADE OF MULCH LAYER.

3 SHRUB / ORNAMENTAL GRASS PLANTING WITH MULCH RING


= 1'-0"

VALERIAN

Landscape Architecture | Urban Design | Irrigation Design | Planning

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UM & GO GAS AND C-STORE
EUDORA DRIVE, COMMERCE CITY, CO
DEVELOPMENT PLAN

KG PROJECT TEAM: EES RDM: RF SDM: DG CPM: BS

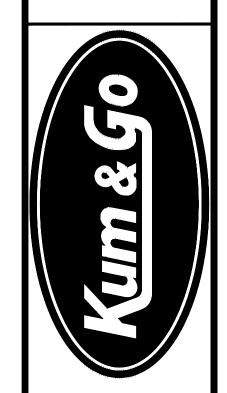7160


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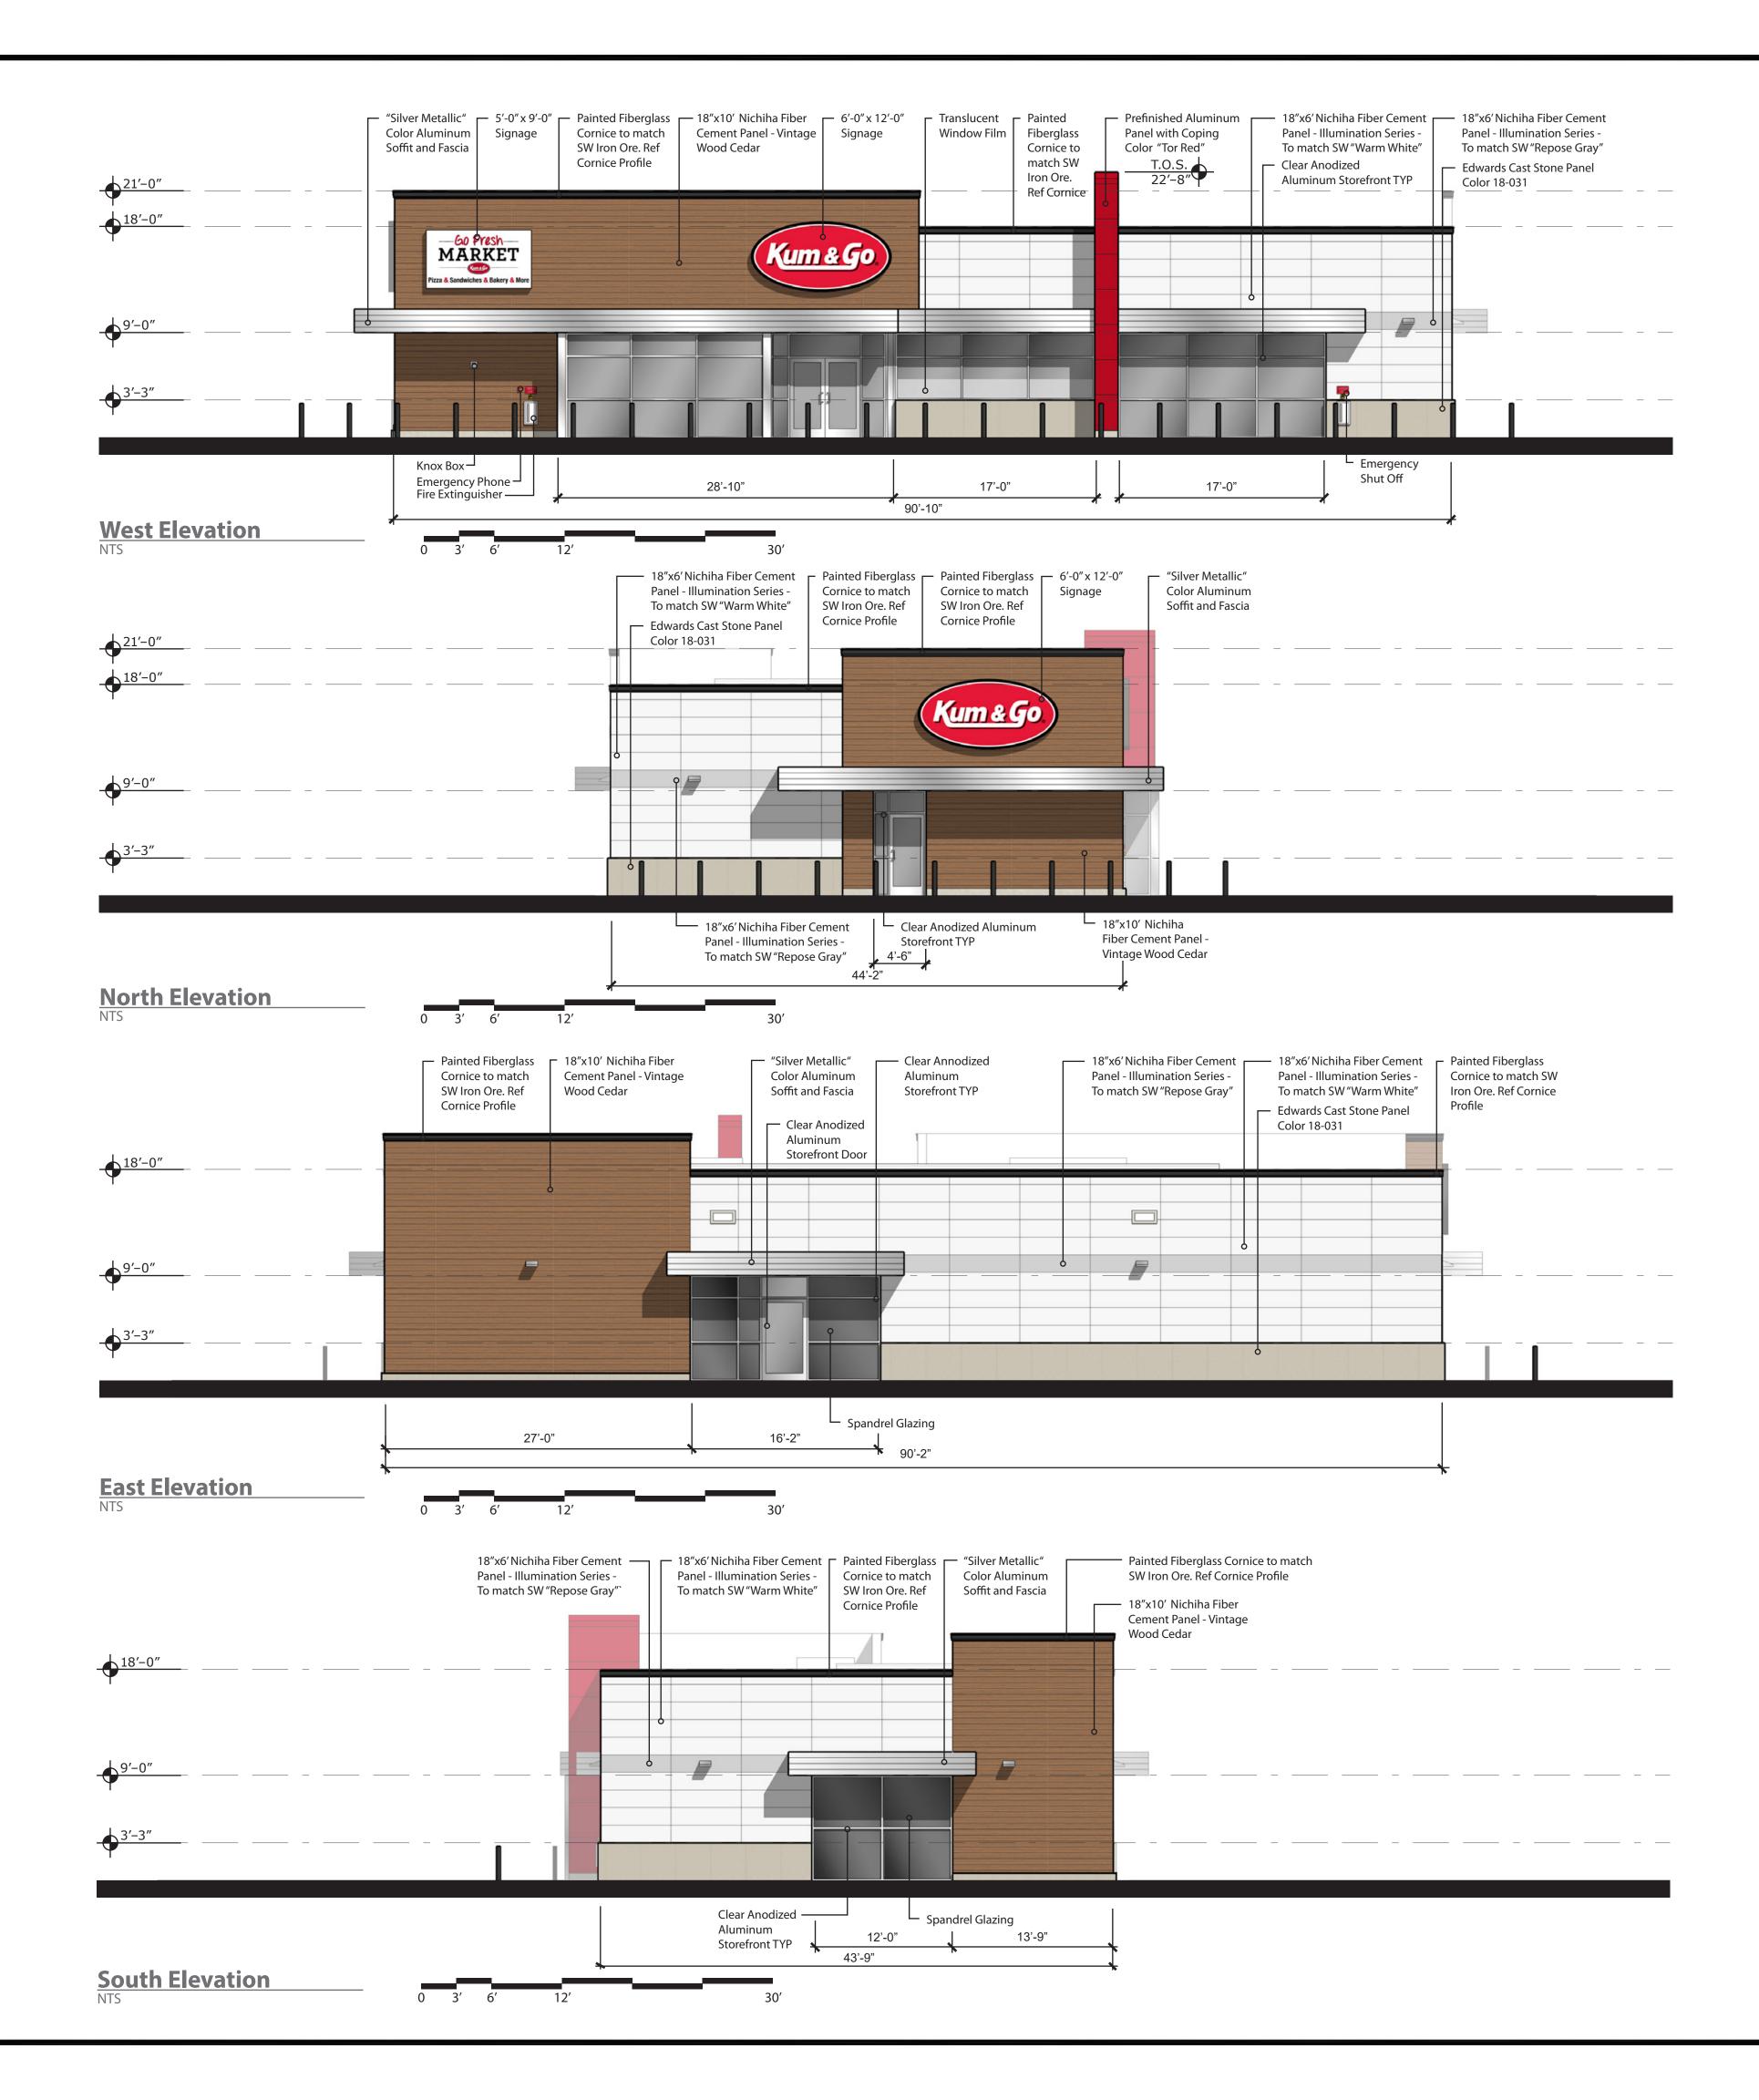
L2.2 8 OF 12

### Proposed Building Signage

Location	Sign	Size	Area
West Elevation	"Kum & Go" Sign	6' x 12'	72 SF
	"Go Fresh Market" Sign	5' x 9'	45 SF
South Elevation	"Kum & Go" Sign	6' x 12'	72 SF
North Elevation	No Signage		0 SF
East Elevation	No Signage		0 SF
	Total		189 SF



Cornice Profile

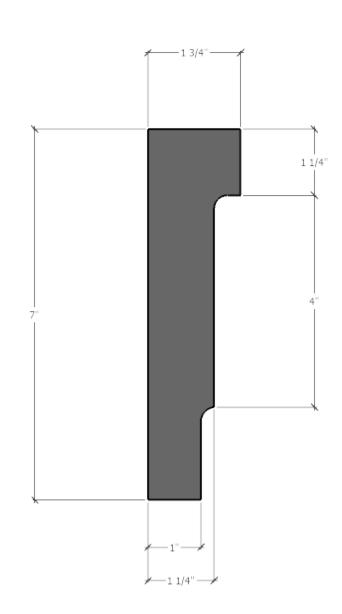



ARCHITECT OF RECORD:
BRR ARCHITECTURE, INC
8131 METCALF AVENUE
SUITE 300
OVERLAND PARK, KS 66204

www.brrarch.com
TEL: 913-262-9095
FAX: 913-262-9044

SEAL



1459 Grand Avenue Des Moines, Iowa 50309 P:515-457-6247

#2300 - COMMERCE CITY, SE CORNER OF E 72ND AVE & VASQUEZ VLBD
EXTERIOR ELEVATIONS

KG PROJECT TEAM:

DATE REVISION DESCRIPTION

07/07/2022 INITIAL SUBMITTAL

REVISIONS


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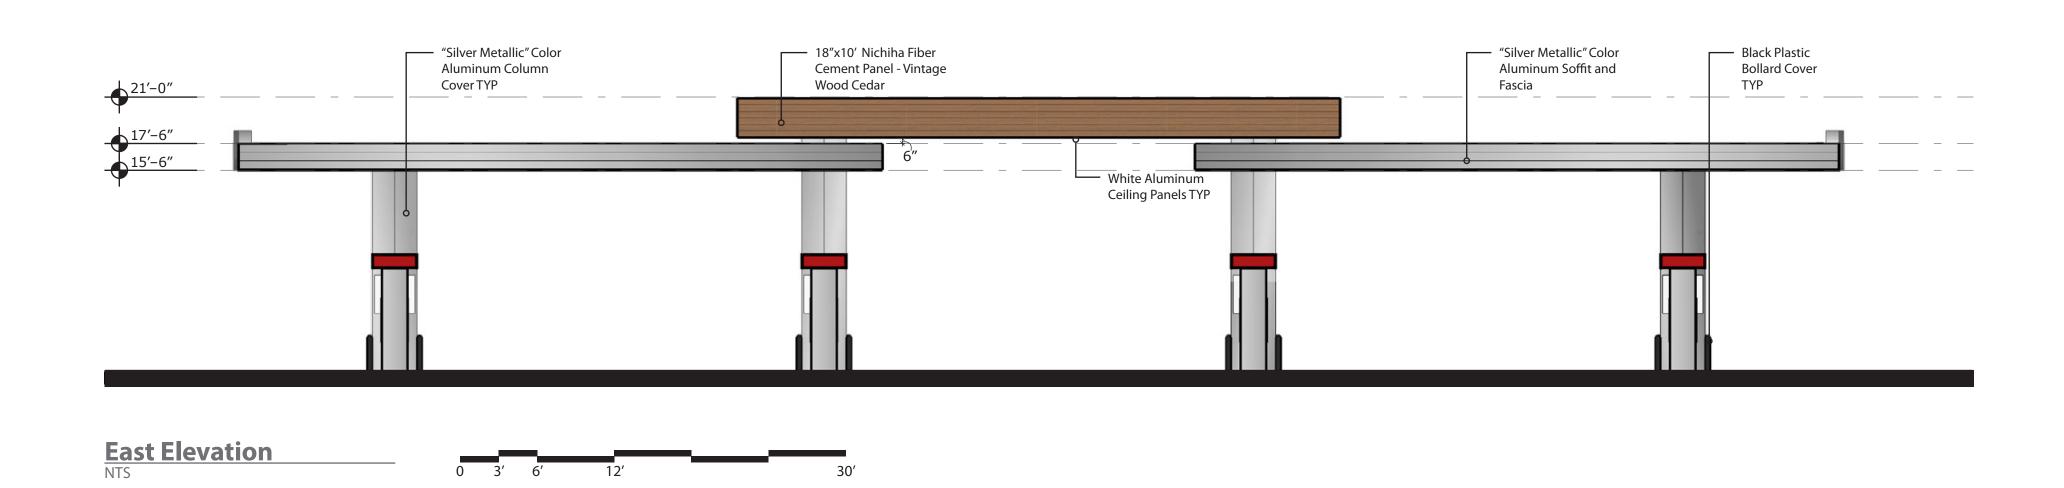
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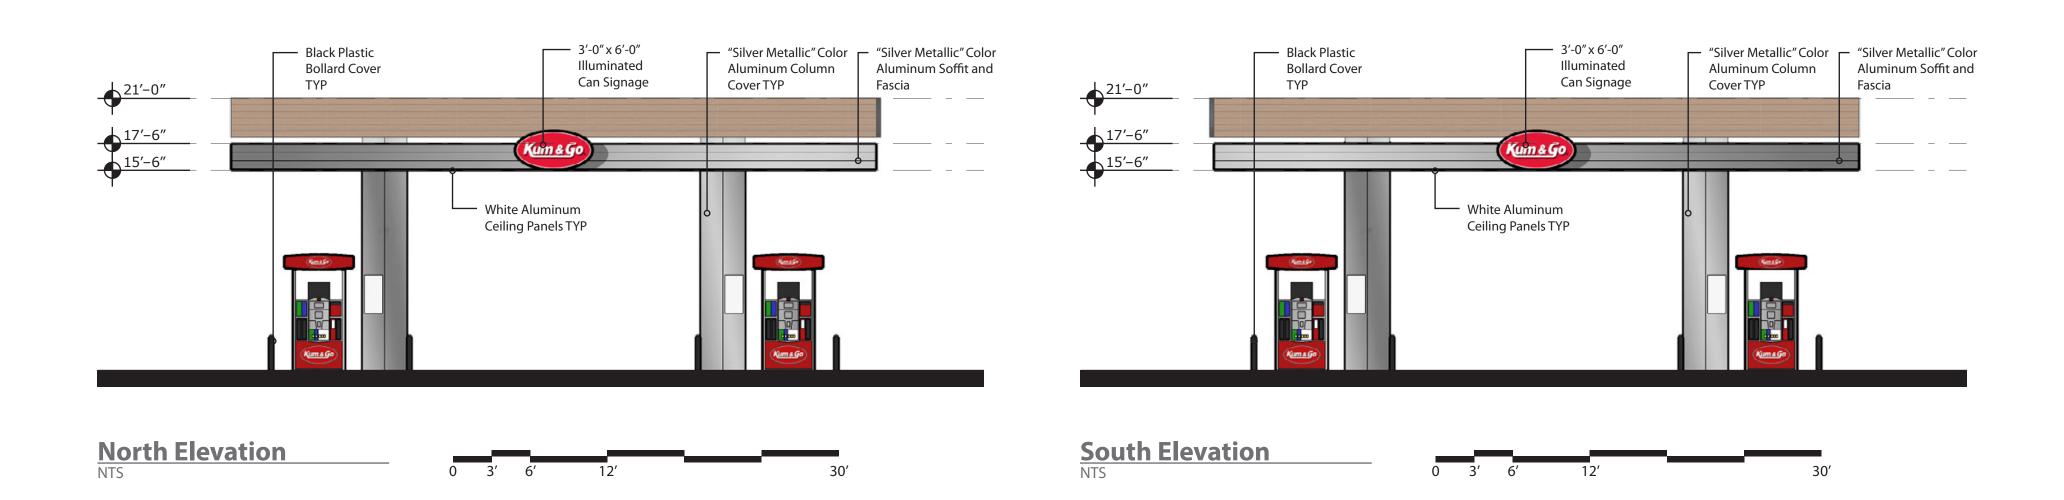
9 OF 12

### **Proposed Canopy Signage**

Location	Sign	Size	Area
West Elevation	"Kum & Go" Sign	3'x 6'	18 SF
East Elevation	No Signage		0 SF
North Elevation	"Kum & Go" Sign	3'x 6'	18 SF
SouthElevation	"Kum & Go" Sign	3'x 6'	18 SF
	Total		54 SF





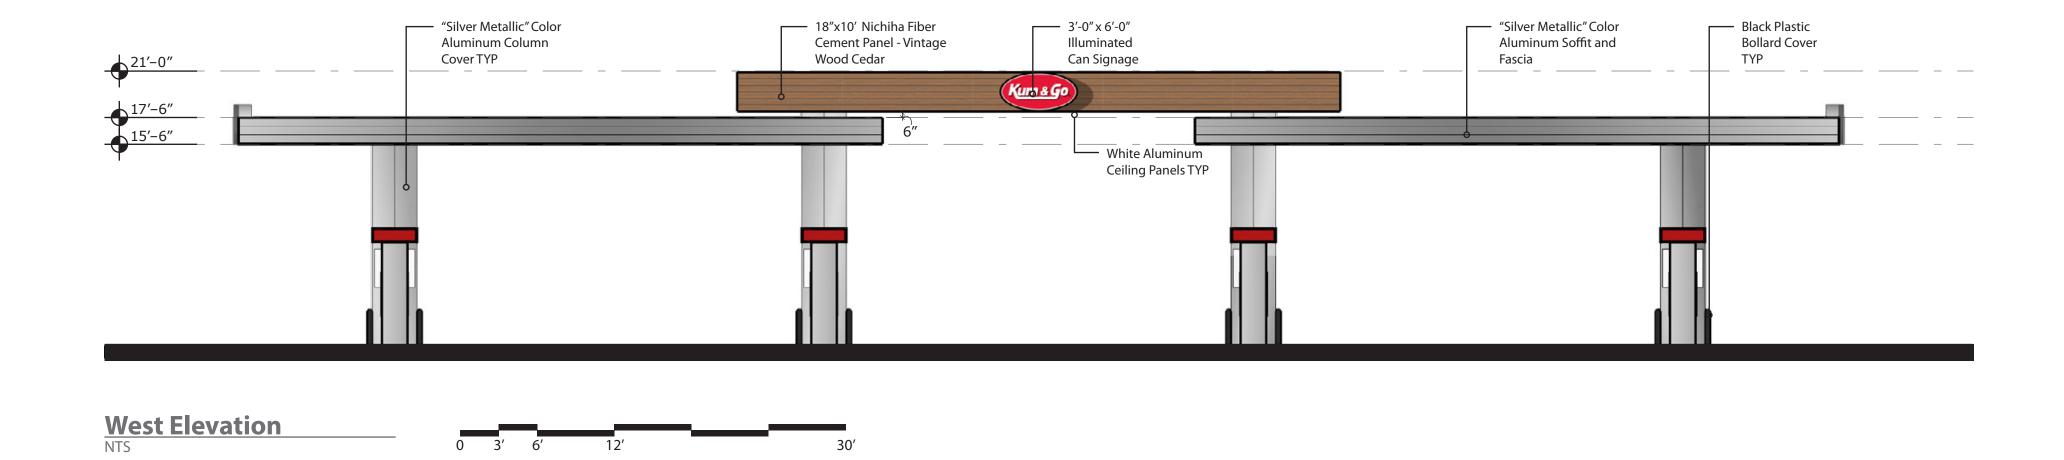



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SEAL



1459 Grand Avenue Des Moines, Iowa 50309 P:515-457-6247

#2300 - COMMERCE CITY, CO SE CORNER OF E 72ND AVE & VASQUEZ VLBD CANOPY ELEVATIONS


KG PROJECT TEAM:
RDM:
SDM:
CPM:

DATE REVISION DESCRIPTION
07/07/2022 INITIAL SUBMITTAL

DATE: 06/28/2022

SHEET NUMBER:

10 OF 12

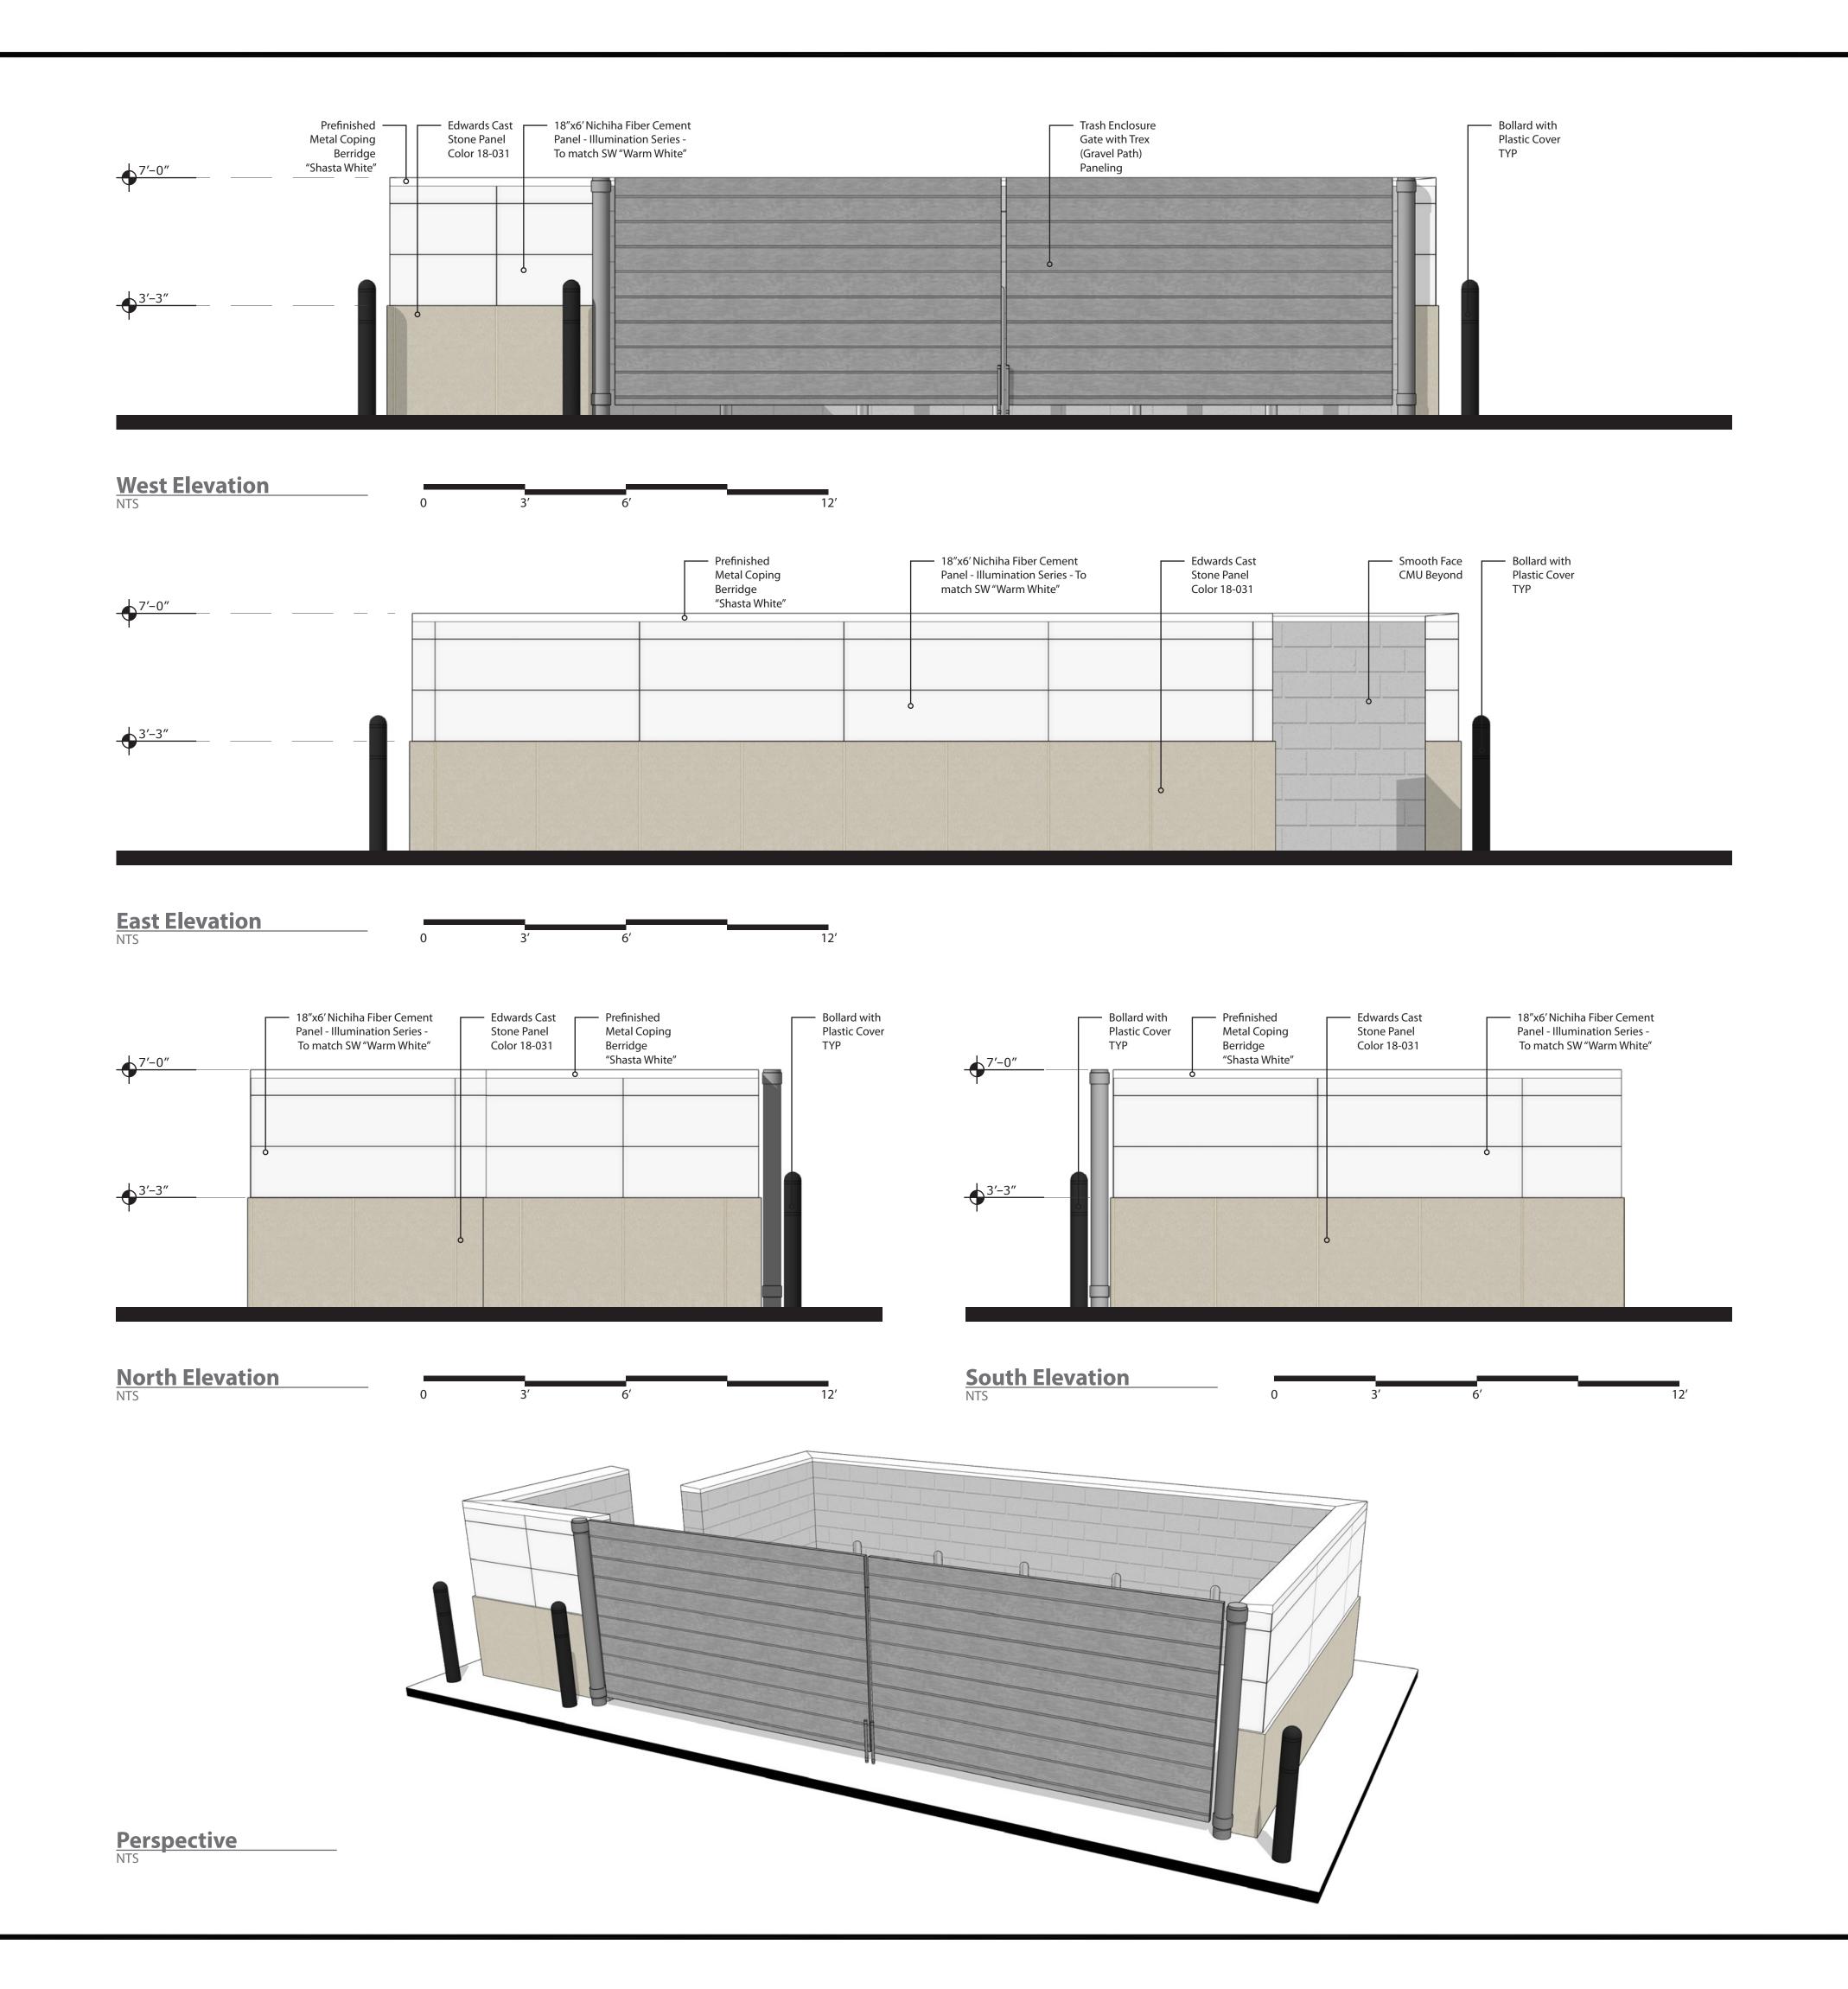

ARCHITECT OF RECORD: BRR ARCHITECTURE, INC 8131 METCALF AVENUE SUITE 300 OVERLAND PARK, KS 66204 www.brrarch.com TEL: 913-262-9095 FAX: 913-262-9044

SEAL



1459 Grand Avenue Des Moines, Iowa 50309 P:515-457-6247

8 \_ ∞ TRASH ENCLOSURE ELEVATIONS

#2300 - COMMERCE CITY, se corner of e 72ND ave & vasquez vlbd

KG PROJECT TEAM: RDM:


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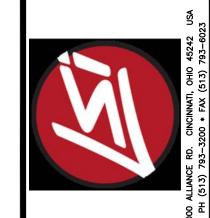
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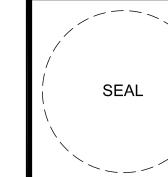
### **DEVELOPMENT PLAN KUM & GO GAS AND C-STORE**


PART OF THE NORTHEAST QUARTER OF SECTION 6, TOWNSHIP 3 SOUTH, RANGE 67 WEST OF THE 6th P.M., CITY OF COMMERCE CITY, ADAMS COUNTY, COLORADO








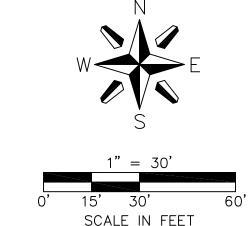

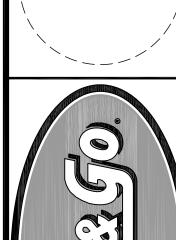

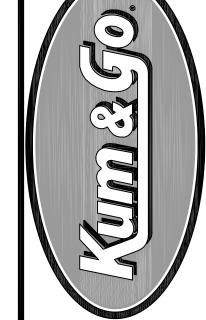

P: 515-226-0128 F: 515-223-9873


**PHOTOME** & VASQUEZ COMMERCE

72nd LO-1561 #2300

KG PROJECT TEAM: SDM: CPM:

REVISION DESCRIPTION	INITIAL SUBMITTAL		
Ш	022		

SHEET NUMBER:

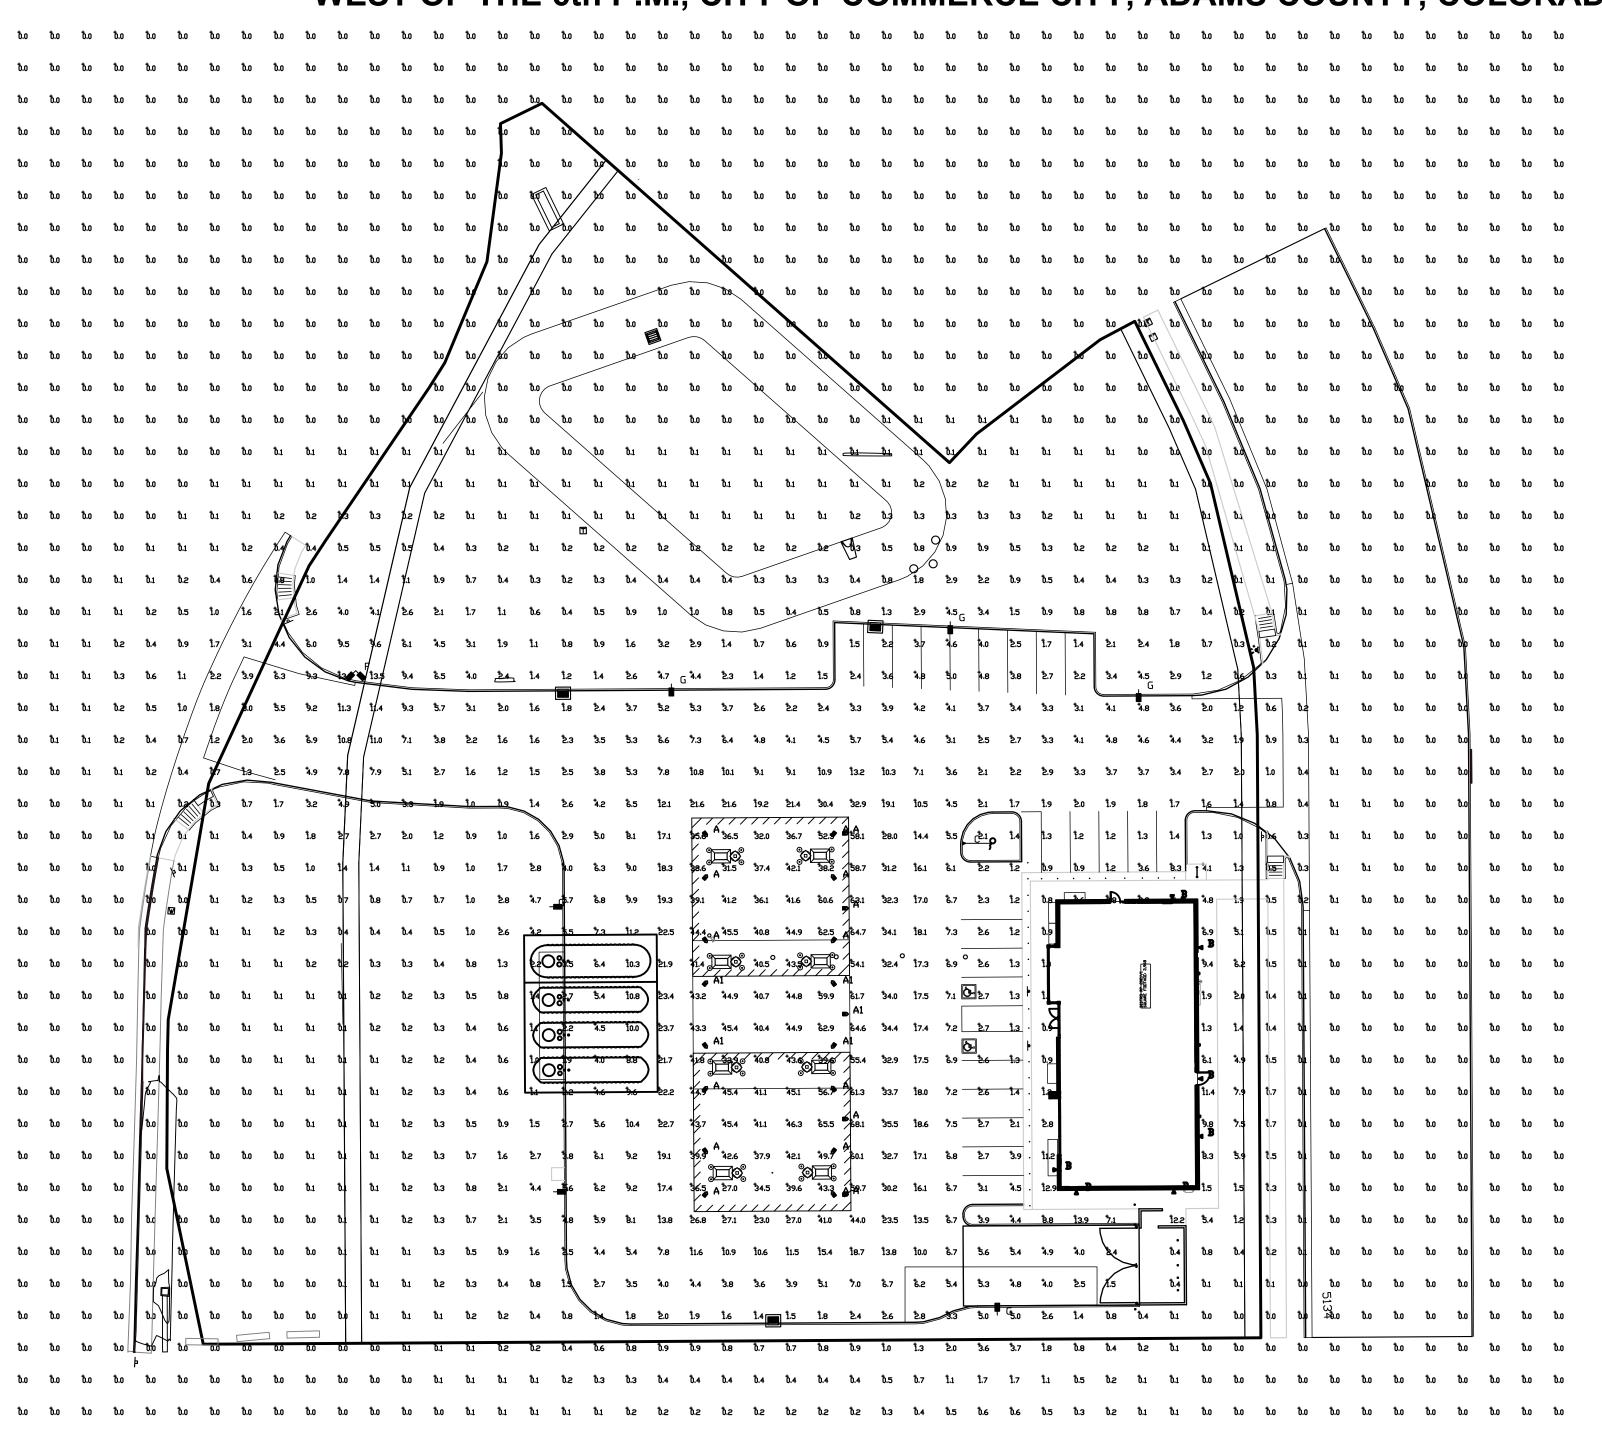

Luminaire Sch	nedule								
Symbol	Qty	Label	Arrangement	Description	LLD	LDD	LLF	Arr. Lum. Lumens	Arr. Watts
	16	А	SINGLE	SCV-LED-23L-SCFT-50-15.5' MT HGT	1.000	1.000	1.000	23101	188
	5	A1	SINGLE	SCV-LED-23L-SCFT-50-17.5' MT HGT	1.000	1.000	1.000	23101	188
•	7	В	SINGLE	WST LED P2 40K VW MVDLT - 11' MH - FIXTURE BY LITHONIA LIGHTING	1.000	1.000	1.000	3512	25
	1	С	SINGLE	TLFL-LED-20L- 4' MH	1.000	1.000	1.000	18768	187.91
\$	1	F	2 @ 90 DEGREES	SLM-LED-18L-SIL-FT-50-70CRI-D90-16'POLE+2.5'BASE	1.000	1.000	1.000	37808	270
<b>B</b>	6	G	SINGLE	SLM-LED-12L-SIL-FT-50-70CRI-SINGLE-16'POLE+2.5'BASE	1.000	1.000	1.000	12861	85

### PHOTOMETRIC EVALUATION NOT FOR CONSTRUCTION

Based on the information provided, all dimensions and luminaire locations shown represent recommended positions. The engineer and/or architect must determine the applicability of the layout to existing or future field conditions.

This lighting plan represents illumination levels calculated from laboratory data taken under controlled conditions in accordance with The Illuminating Engineering Society (IES) approved methods. Actual performance of any manufacturer's luminaires may vary due to changes in electrical voltage, tolerance in lamps/LED's and other variable field conditions. Calculations do not include obstructions such as buildings, curbs, landscaping, or any other architectural elements unless noted. Fixture nomenclature noted does not include mounting hardware or poles. This drawing is for photometric evaluation purposes only and should not be used as a construction document or as a final document for ordering product.

Label	CalcType	Units	Avg	Max	Min	Avg/Min	Ma×/Min
ALL CALC POINTS	Illuminance	Fc	3.03	68.1	0.0	N.A.	N.A.
CANDPY	Illuminance	Fc	46.15	68.1	27.0	1.71	2.52
INSIDE CURB	Illuminance	Fc	7.99	44.0	0.9	8.88	48.89