A PARCEL OF LAND SITUATED IN THE NORTHWEST 1/4 OF SECTION 28, TOWNSHIP 2 SOUTH, RANGE 67 WEST OF THE 6TH P.M., CITY OF COMMERCE CITY, COUNTY OF ADAMS, STATE OF COLORADO

LEGAL DESCRIPTION:

LOT 1, D.I.A. SUBDIVISION, COUNTY OF ADAMS, STATE OF COLORADO

ALSO KNOWN BY THE STREET AND NUMBER AS 8550 ROSEMARY STREET, COMMERCE CITY, CO 80022-5055

BENCHMARK:

THE WEST QUARTER CORNER OF SECTION 28-T2S-R67W (A FOUND 2.5" ALUMINUM CAP STAMPED "GEOSURV 1999 PLS 22097" IN BOX 0.4' BELOW GRADE. NAVD 1988 DATUM ELEVATION:5134.94

BASIS OF BEARINGS:

THE GPS DERIVED WEST LINE OF THE NORTHWEST QUARTER OF SECTION 28, TOWNSHIP 2 SOUTH, RANGE 67 WEST OF THE 6TH PRINCIPAL MERIDIAN AS EVIDENCED BY THE WEST QUARTER CORNER (A FOUND 2.5" ALUMINUM CAP IN BOX 0.4' BELOW GRADE) FROM WHENCE THE NORTHWEST CORNER OF SAID SECTION 28 (A FOUND 3.25" ALUMINUM CAP 0.5' BELOW GRADE IN BOX) BEARS NORTH 00°19'54" EAST A DISTANCE OF 2648.70 FEET WITH ALL BEARINGS HEREIN RELATIVE THERETO.

GENERAL NOTES:

- 1. LIGHTING NOTE: IN THE INTEREST OF COMPATIBILITY OF SURROUNDING LAND USES, ILLUMINATION OF ANY KIND ON PRIVATE PROPERTY SHALL BE DIRECTED AND CONTROLLED IN SUCH A MANNER SO THAT THERE SHALL BE NO DIRECT RAYS OF LIGHT WHICH EXTEND BEYOND THE BOUNDARIES OF THE PROPERTY FROM WHICH IT ORIGINATES.
- 2. TRASH ENCLOSURE NOTE: TRASH ENCLOSURES SHALL BE CONSTRUCTED TO A MINIMUM HEIGHT OF 6-FEET AND OF THE SAME OR COMPLIMENTARY MATERIAL AND COLOR AS THE MAIN BUILDING.
- 3. SCREENING NOTE: ROOF MOUNTED ELECTRICAL AND MECHANICAL EQUIPMENT SHALL BE PLACED OR SCREENED SUCH THAT THE EQUIPMENT IS NOT VISIBLE FROM ANY POINT. SUCH EQUIPMENT SHALL BE SCREENED WITH THE SAME MATERIALS AND COLORS AS THE MAIN BUILDING.
- 4. SIGNAGE NOTE: APPROVAL OF A SIGN PERMIT IS REQUIRED IN ADDITION TO DEVELOPMENT PLAN APPROVAL. SIGN LOCATIONS SHOWN ON THE DEVELOPMENT PLAN WILL BE REVIEWED FOR POSSIBLE CONFLICTS WITH SIGHT TRIANGLES AND EASEMENTS. THESE SIGNS WILL NOT BE APPROVED BY THE DEVELOPMENT PLAN REVIEW PROCESS OR APPROVAL OF THIS DEVELOPMENT PLAN. ALL SIGNS MUST CONFORM TO THE CITY'S STANDARDS.
- 5. FENCING NOTE: APPROVAL OF A FENCE PERMIT IS REQUIRED IN ADDITION TO DEVELOPMENT PLAN APPROVAL. ALL FENCES MUST CONFORM TO THE CITY'S STANDARDS.
- 6. DOWNSPOUT NOTE: NO ROOF DOWNSPOUT OUTFALLS WILL BE ALLOWED TO DRAIN OVER SIDEWALKS, BIKE PATHS, OR ANY OTHER PEDESTRIAN ROUTE.
- 7. AMERICANS WITH DISABILITIES NOTE: THE APPLICANT HAS THE OBLIGATION TO COMPLY WITH ALL APPLICABLE REQUIREMENTS OF THE AMERICAN DISABILITIES ACT. APPROVAL OF THIS DEVELOPMENT PLAN DOES NOT CONSTITUTE COMPLIANCE WITH THIS ACT.
- 8. 8-CONSTRUCTION NOTE: THE APPROVAL OF THIS DEVELOPMENT PLAN DOES NOT CONSTITUTE FINAL APPROVAL OF GRADING, DRAINAGE, UTILITY, PUBLIC IMPROVEMENTS AND BUILDING PLANS. THESE PLANS MUST BE REVIEWED AND APPROVED BY THE APPROPRIATE AGENCY PRIOR TO THE ISSUANCE OF BUILDING PERMITS.
- 9. UNDERGROUND UTILITY NOTE: ALL OVERHEAD UTILITIES SERVING THIS SITE MUST BE PLACED UNDERGROUND PER THE LAND DEVELOPMENT CODE.

NOTES:

- DEFAULT TO THE LDC FOR ANY STANDARD NOT ADDRESSED BY THE PUD.
- ACCESS IS PRELIMINARY AND SUBJECT TO FINAL APPROVAL BY PUBLIC WORKS.
 DRAINAGE IS PRELIMINARY AND SUBJECT TO FINAL APPROVAL BY PUBLIC WORKS.
- 4. NO CUSTOMIZED DESIGN ELEMENTS (FENCING LANDSCAPING, SIGNAGE, ARCHITECTURAL DESIGN STANDARDS, LIGHTING, PUBLIC ART, PEDESTRIAN CONNECTIVITY, OPEN SPACE, ETC.) ARE PROPOSED, DEFAULT TO THE LDC STANDARDS
- 5. NO CUSTOM STREET CROSS-SECTIONS ARE PROPOSED, DEFAULT TO THE CITY'S STANDARD STREET CROSS-SECTIONS.

VICINITY MAP SCALE 1" = 2000'

CONTACTS:

CIVIL ENGINEER:

HCI ENGINEERING A DIVISION OF HABERER CARPENTRY INC. ATTN: GARRETT GOODLIN, PE 621 SOUTHPARK DR., SUITE 1600 LITTLETON, CO 80210 PH: 303-979-3900

LANDSCAPE ARCHITECT:

FALCON SURVEYING, INC. ATTN: JEFF MACKENNA 9940 WEST 25TH AVE., LAKEWOOD, CO 80215 PH: 303-202-1560

SURVEYOR:

ARCHITECT:

ATTN:CHUCK PELL

AURORA, CO 80016

PH: 303-718-1343

C. PELL, ARCHITECT, LLC

6354 SOUTH BLACKHAWK WAY

OWNER:

 JUMP DESIGN COMPANY
 GER

 ATTN: TOM JUMP
 ATTN

 1733 S. CLARKSON STREET
 4380

 DENVER, CO 80210
 DENV

 PH: 303 - 282 - 7292
 PH: 7

GERARDO GARCIA ATTN:CHUCK PELL 4380 DEL RIO CT. DENVER,CO 80239 PH: 720 - 226 - 7292

SITE STAT	ISTICS		
ROW	SQ. FT.	ACRES	
GROSS LOT AREA	61,571	1.505	
ROW DEDICATION REC.NO. 2022 0000 20669	3,979	0.091	
NET LOT AREA	61,571	1.414	
PROPOSED BUILDING GROSS AREA	7,197	0.165	
GROSS LANDSCAPE AREA	28,015	0.688	
NET LANDSCAPE AREA	28,015	0.595	
GROSS HARD SURFACE AREA	26,359	0.651	
NET HARD SURFACE AREA	26,359	0.764	
F.A.R	11.69%		
BUILDING CONSTRUCTION TYPE	III-B		
BUILDING OCCUPANCY GROUP	M		
CURRENT ZONING	I-1		
NUMBER OF EMPLOYEES		2	
PARKING REQUIREMENTS	REQUIRED	PROVIDED	
STANDARD PARKING	32	34	
ACCESSIBLE PARKING	2	2	


PROPERTY LINE CURB AND GUTTER (SPILL) _____ __ __ __ __ __ **CURB AND GUTTER (CATCH)** ______ STORM SEWER --- ST -- ST -- ST --SANITARY SEWER WATER LINE -- w-- w-- w-- w--GAS LINE -- G-- G-- G-- G--**ELECTRICAL** —— E——— E——— E—— OVERHEAD POWER LINES ——— — OHE ——— OHE ——— FIBER OPTIC LINE — — F0 — F0 — F0 — CEF **ELECTRICAL BOX** SITE LIGHT **MANHOLES** INLET **METER PIT GATE VALVE** THRUST BLOCK **CLEAN OUT** TREE **UTILITY POLE GAS METER** FIRE HYDRANT XXX <u>(XXX)</u> SLOPE — — 5420- — — — **MAJOR CONTOUR** MINOR CONTOUR **SPOT ELEVATION**

MASTER LEGEND

PROPOSED

EXISTING

HATCHING LEGEND

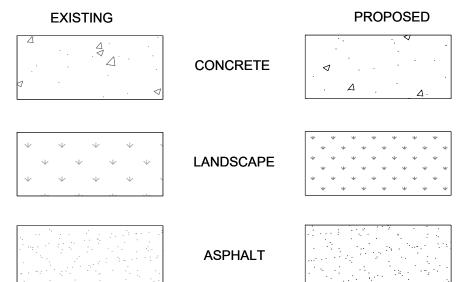

Sheet List Table				
Sheet Number	Sheet Title			
C1.0	COVER			
C2.0	SITE PLAN			
C3.0	GRADING PLAN			
C4.0	UTILITY PLAN			
L1.0	LANDSCAPE PLAN			
L2.0	LANDSCAPE DETAILS			
A1.0	BUILDING ELEVATIONS			
A1.1	ELEVATIONS			
A2.0	MATERIAL BOARD			
PH1.0	PHOTOMETRICS			
PH2.0	FIXTURE CUT SHEETS			
	1			

CITY STAFF CERTIFICATE

APPROVED BY THE DEPARTMENT OF COMMUNITY DEVELOPMENT OF COMMERCE CITY, THIS _____DAY OF _____,2022.

PIN: 01721000000008

A DIVISION OF

HABERER CARPENTRY INC.
621 SOUTHPARK DR., SUITE 1600
LITTLETON CO, 80120
PHONE: (303) 979-3900
INFO@HABERERGROUP.COM

Know what's **below**,
Call before you dig.

CALL 811 2-BUSINESS DAYS IN ADVANCE BEFORE YOU DIG, GRADE, OR EXCAVATE FOR THE MARKING OF UNDERGROUND MEMBER UTILITIES.

SOU ROSEMARY

ELOPMENT PLAN

TGG

2023-05-24


Sheet Name:
COVER
Sheet
Number:


Checked By:

Date Issued:

C1.0

A PARCEL OF LAND SITUATED IN THE NORTHWEST 1/4 OF SECTION 28, TOWNSHIP 2 SOUTH, RANGE 67 WEST OF THE 6TH P.M., CITY OF COMMERCE CITY, COUNTY OF ADAMS, STATE OF COLORADO

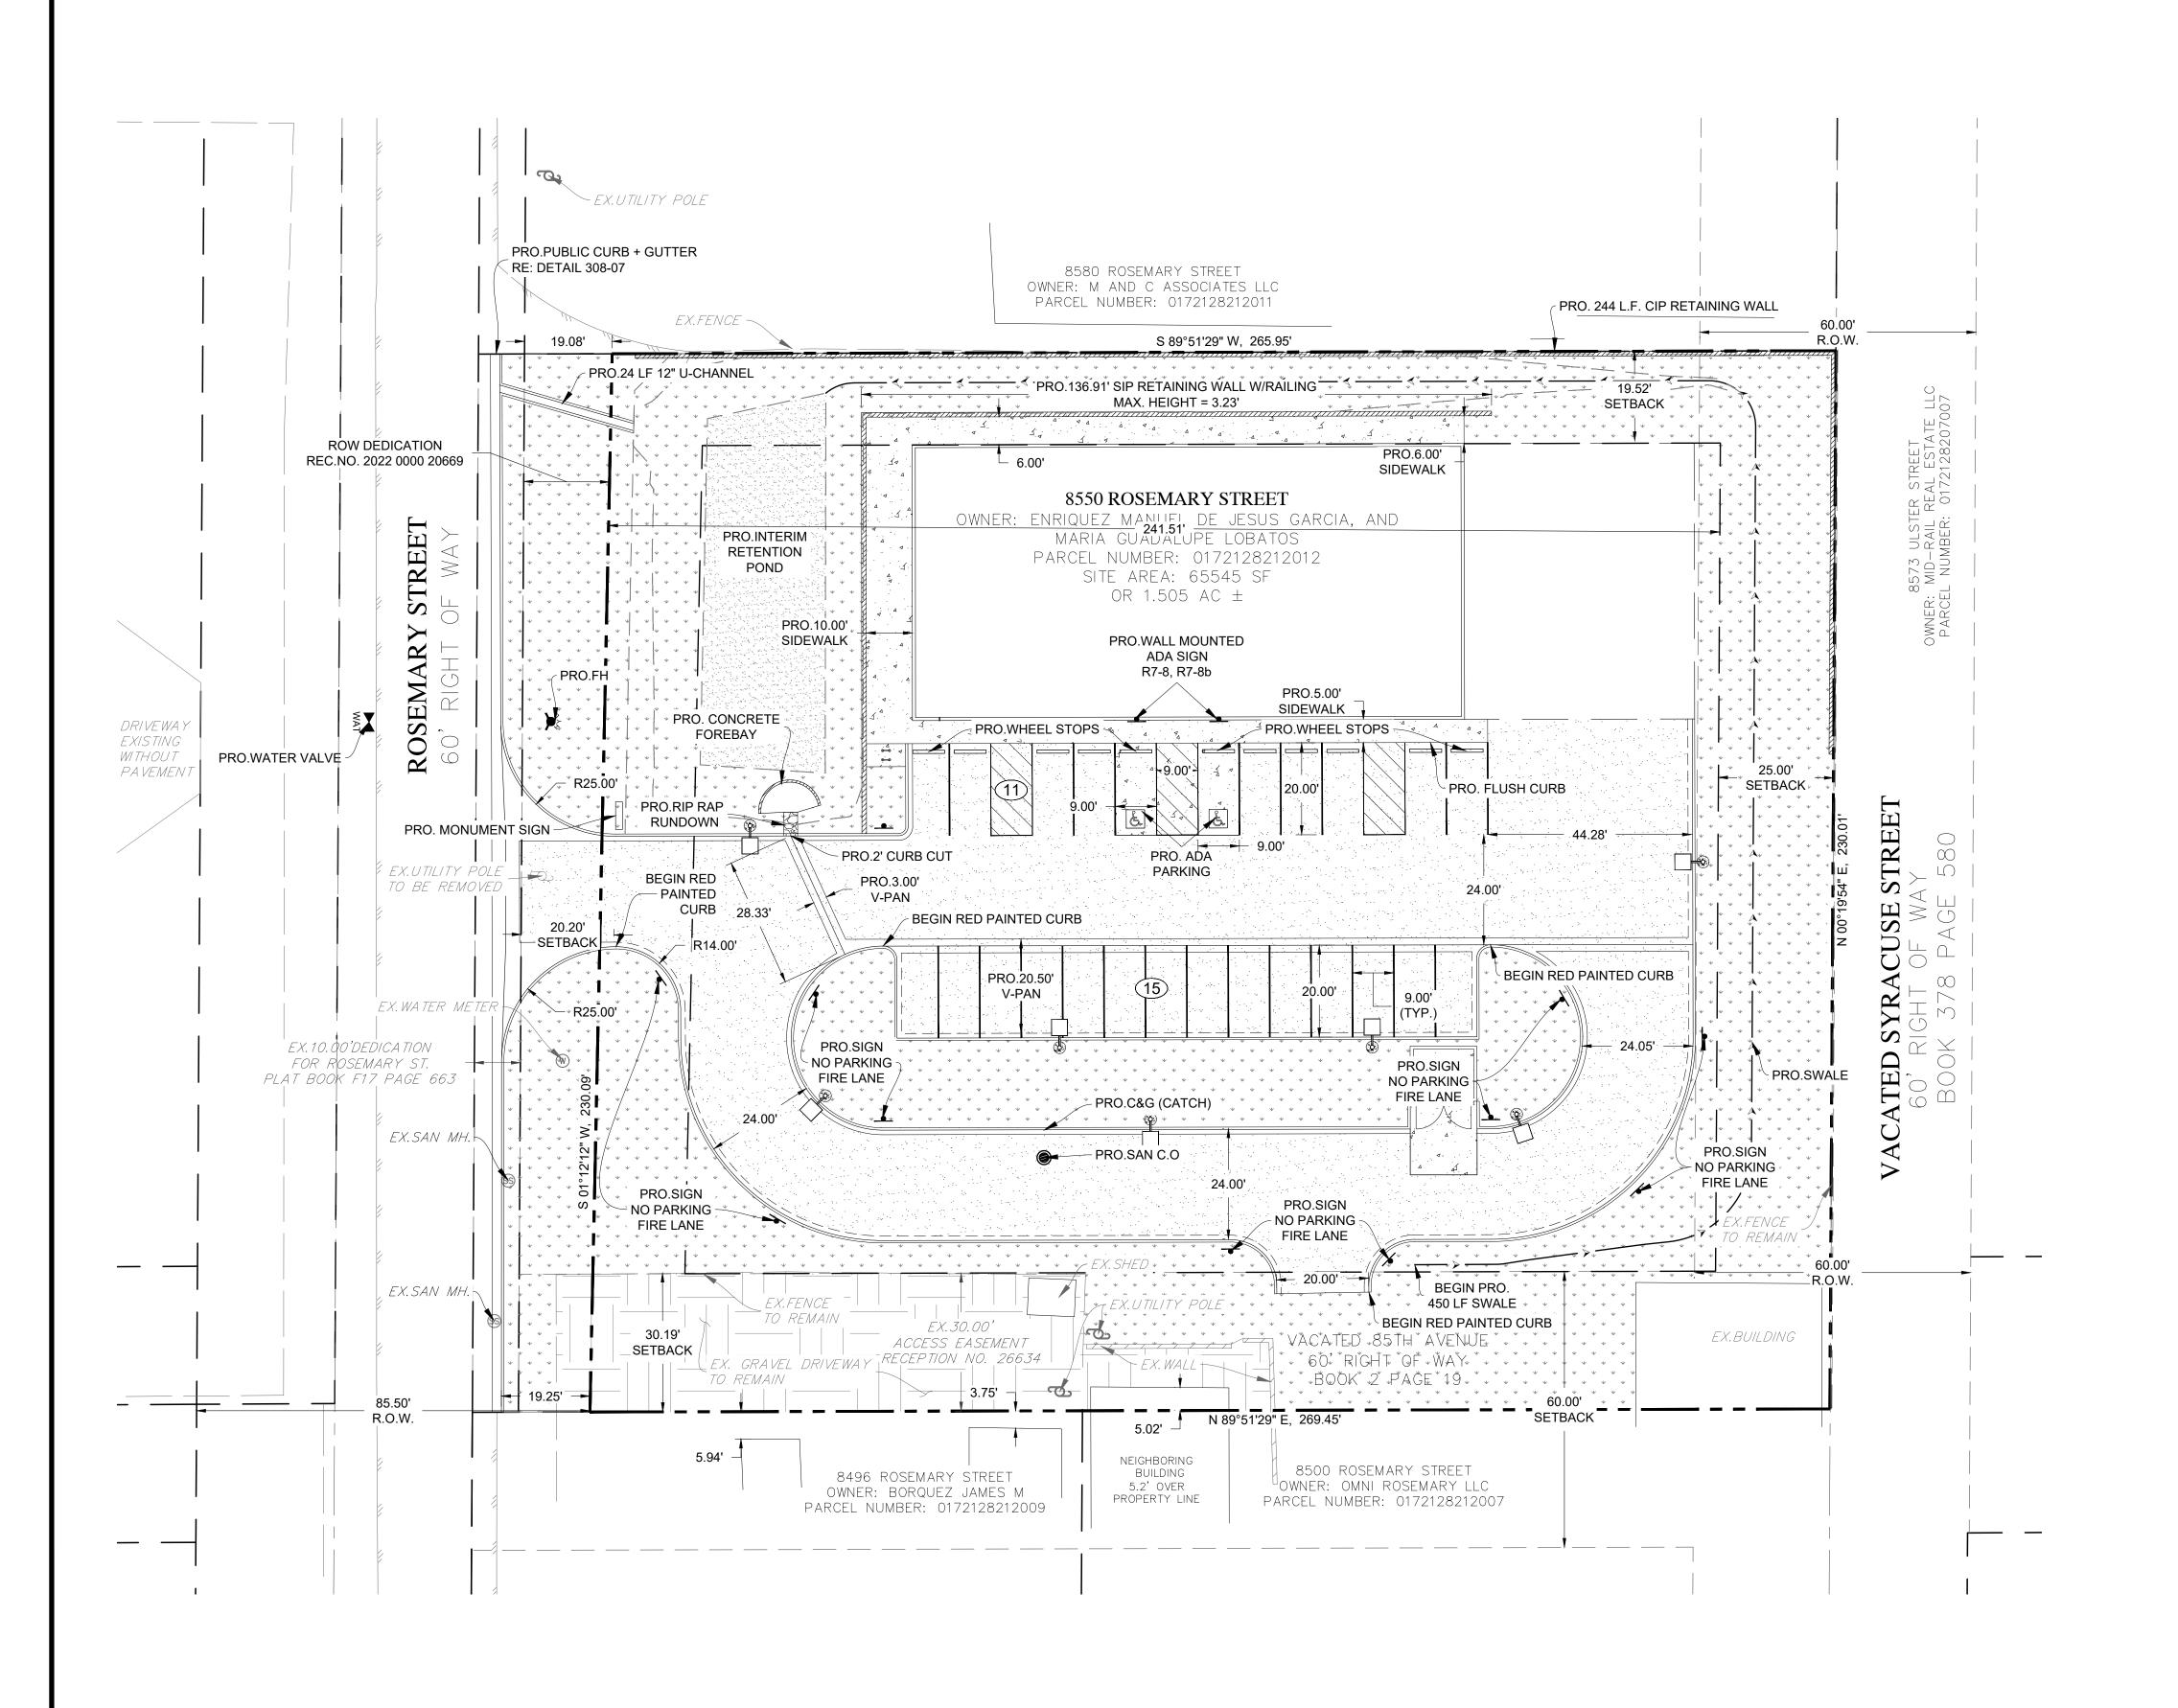

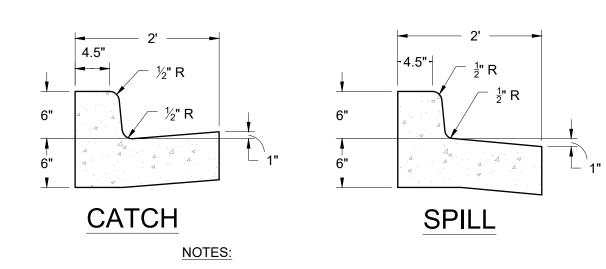


1. 4500 PSI CONCRETE WITH FIBERMESH REINFORCEMENT.

2. BRUSHED FINISH ON ALL EXPOSED CONCRETE.

PRIVATE CURB & GUTTER

Scale: N.T.S.

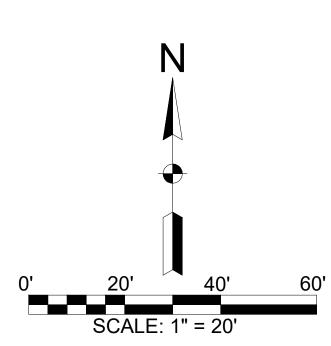

CITY STAFF CERTIFICATE

APPROVED BY THE DEPARTMENT OF COMMUNITY DEVELOPMENT OF COMMERCE CITY, THIS ____ ____DAY OF_____,2022.

DEPARTMENT OF COMMUNITY DEVELOPMENT

PIN: 01721000000008

A DIVISION OF HABERER CARPENTRY INC. 621 SOUTHPARK DR., SUITE 1600 LITTLETON CO, 80120 PHONE: (303) 979-3900

INFO@HABERERGROUP.COM


Know what's below, Call before you dig.

CALL 811 2-BUSINESS DAYS IN ADVANCE BEFORE YOU DIG, GRADE, OR EXCAVATE FOR THI MARKING OF UNDERGROUND MEMBER UTILITIES.

REVISIONS: 1 1.21.22 1ST SUB 5.24.23 2ND SUB

Project No: HCI 20_01 Drawn By: ZKA Checked By: 2023-05-24 Date Issued:

Sheet Name: SITE PLAN Sheet Number:

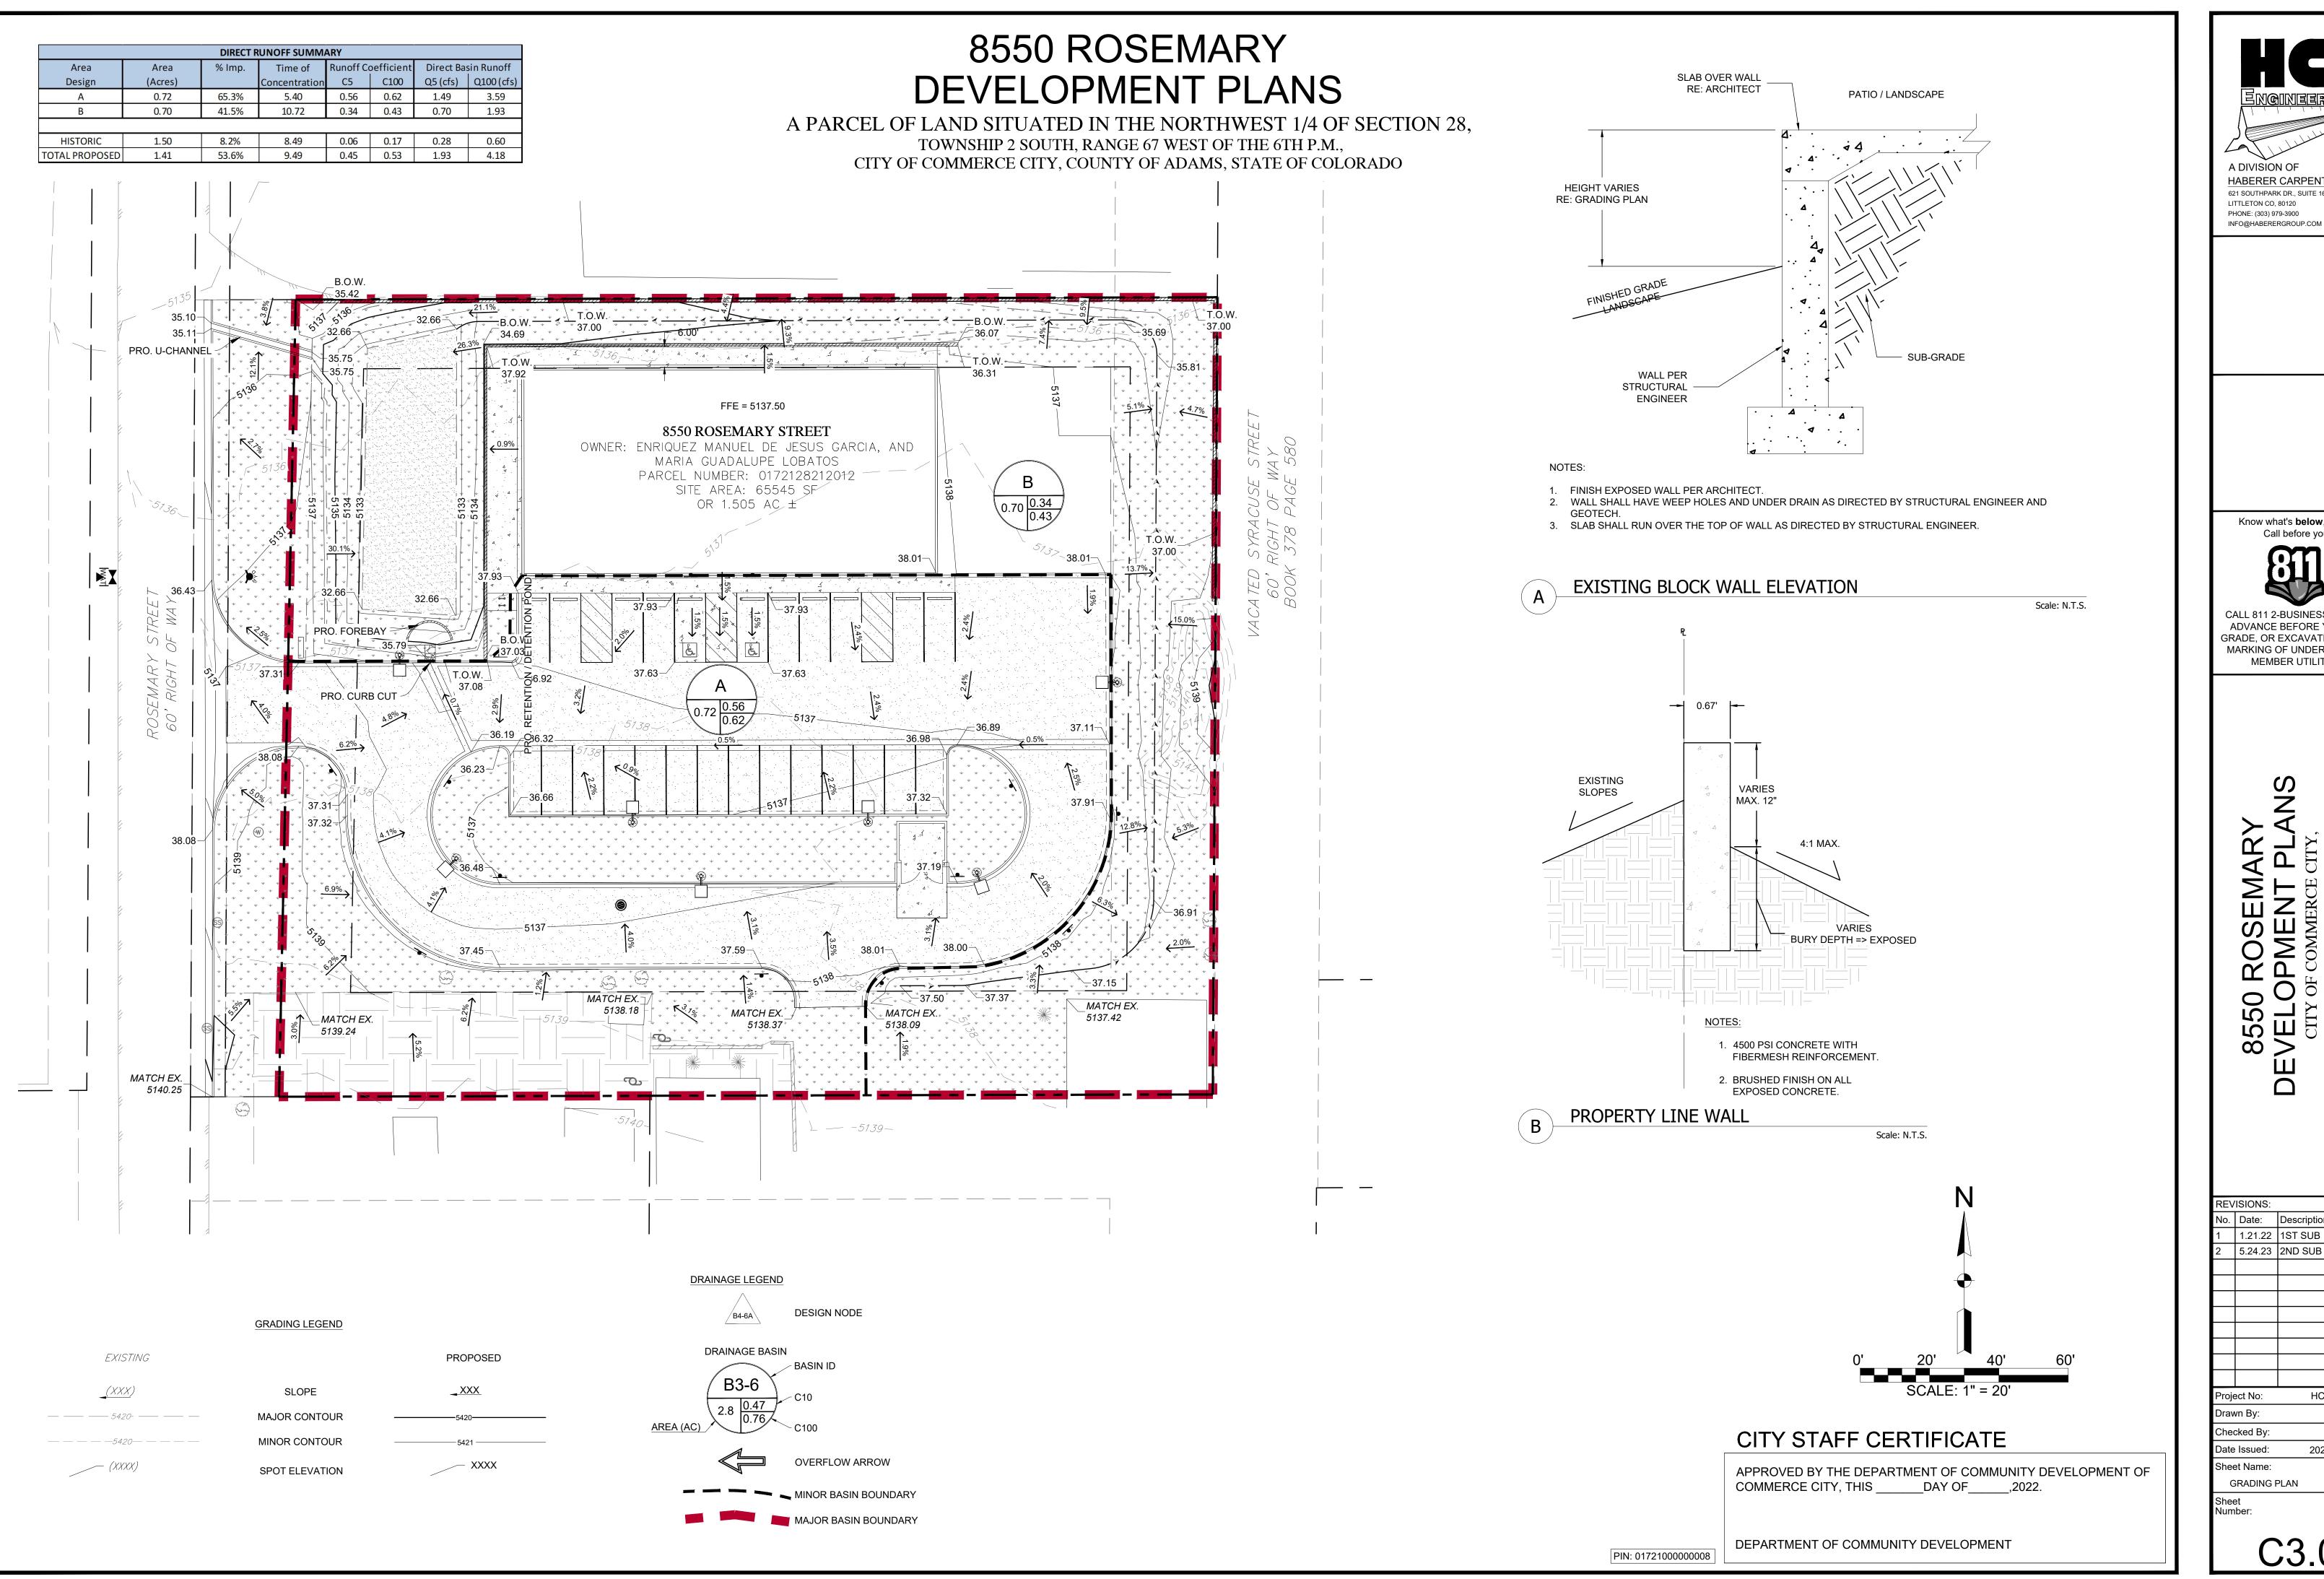

621 SOUTHPARK DR., SUITE 1600 LITTLETON CO, 80120

> Know what's below, Call before you dig.

CALL 811 2-BUSINESS DAYS IN ADVANCE BEFORE YOU DIG, GRADE, OR EXCAVATE FOR THE MARKING OF UNDERGROUND MEMBER UTILITIES.


REVISIONS: 1.21.22 | 1ST SUB

5.24.23 2ND SUB HCI 20_01 Project No: ZKA Checked By:


2023-05-24 Date Issued:

GRADING PLAN

A PARCEL OF LAND SITUATED IN THE NORTHWEST 1/4 OF SECTION 28, TOWNSHIP 2 SOUTH, RANGE 67 WEST OF THE 6TH P.M., CITY OF COMMERCE CITY, COUNTY OF ADAMS, STATE OF COLORADO

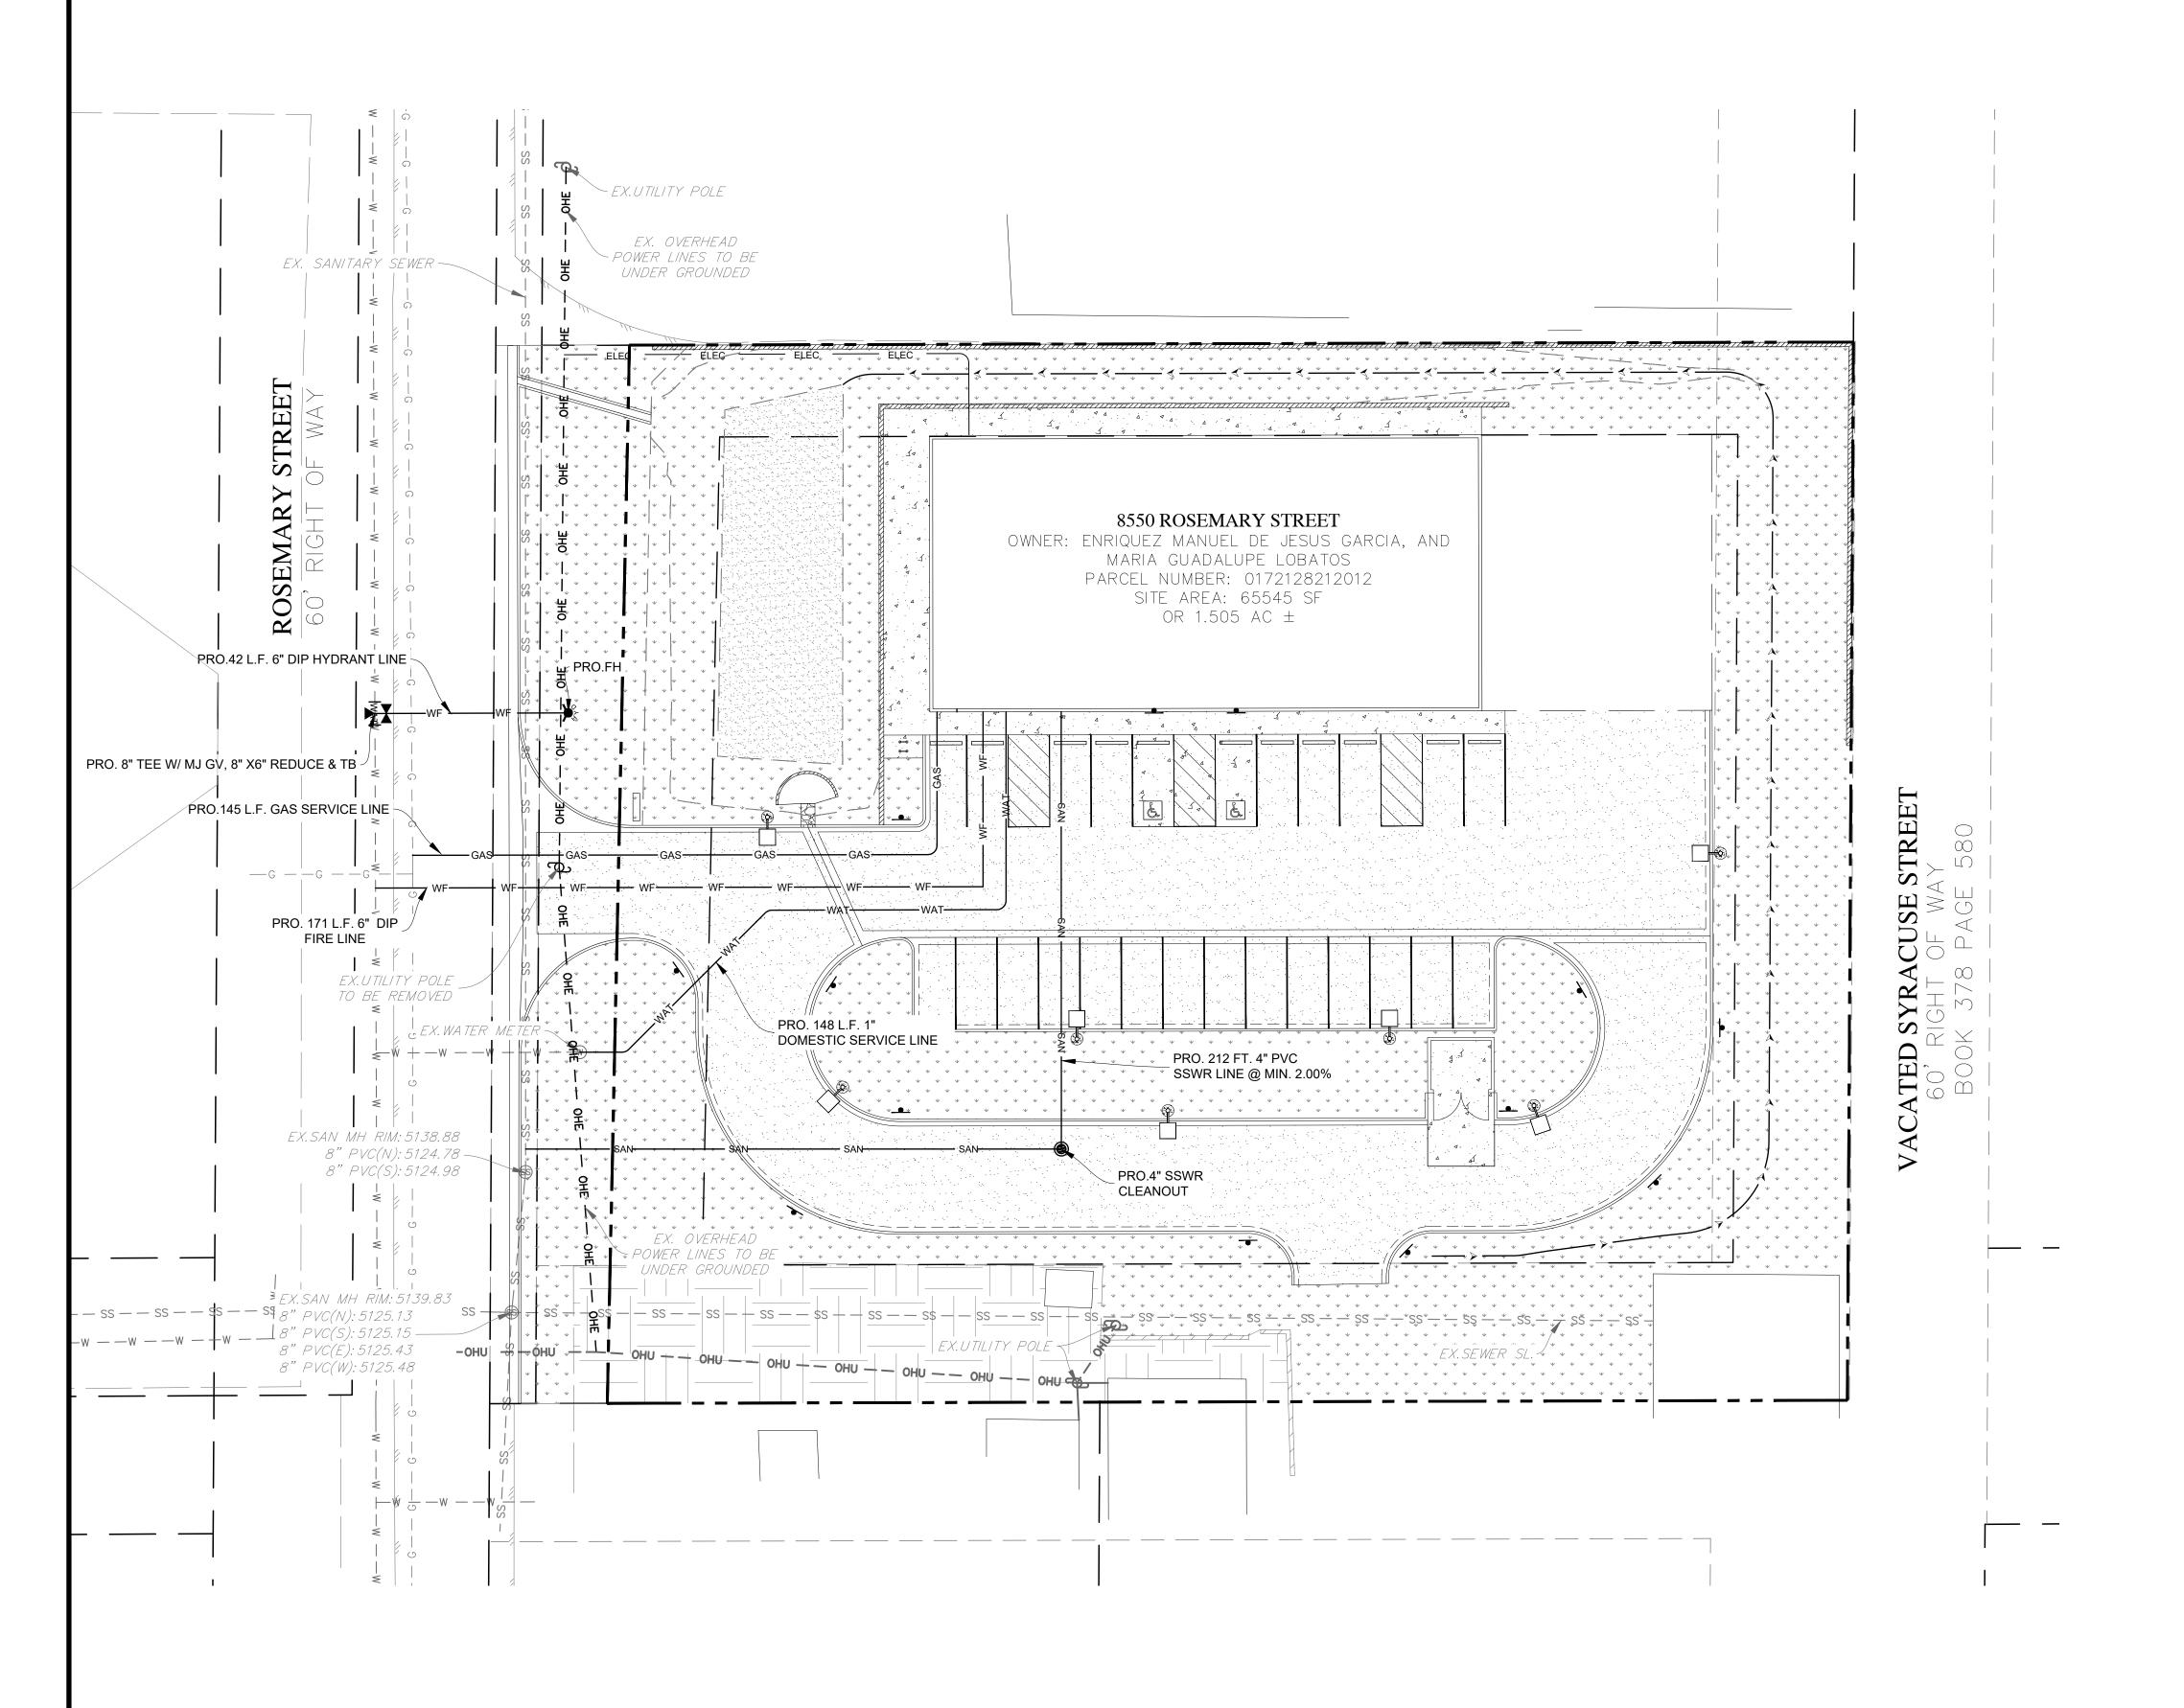


UTILITY LEGEND

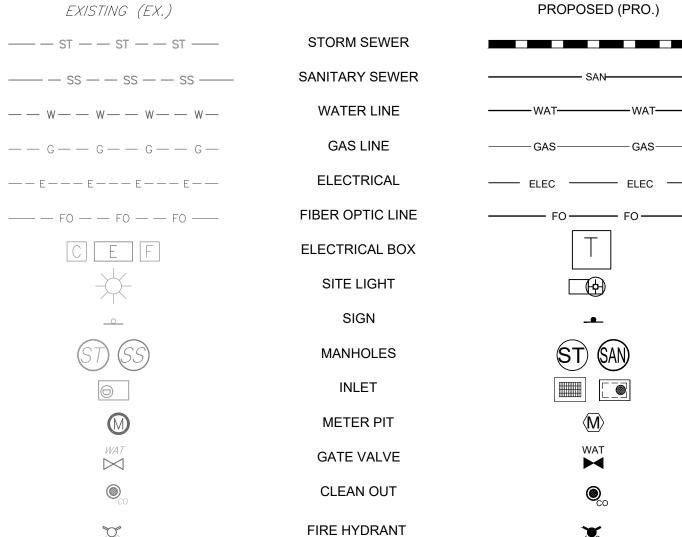

SOUTH ADAMS COUNTY FIRE DEPARTMENT NOTES:

- 1. PRIVATE FIRE SERVICE LINES AND APPURTENANCES SHALL BE INSTALLED AND MAINTAINED IN ACCORDANCE WITH SOUTH ADAMS COUNTY WATER AND SANITATION DISTRICT AND NATIONAL FIRE PROTECTION ASSOCIATION STANDARD 24.
- 2. UNDERGROUND WATER SUPPLY CONTRACTORS INSTALLING PRIVATE FIRE SERVICE MAINS AND APPURTENANCES SHALL BE LICENSED WITH THE STATE OF COLORADO DIVISION OF FIRE PREVENTION AND CONTROL AS A FIRE SUPPRESSION SYSTEMS CONTRACTOR - UNDERGROUND. THE STATE OF COLORADO LICENSE SHALL BE SUBMITTED TO THE SOUTH ADAMS COUNTY FIRE DEPARTMENT.
- 3. PRIVATE FIRE SERVICE LINES INCLUDING SPECIFICATION DATA SHEETS FOR ALL MATERIAL SHALL BE SUBMITTED TO THE SOUTH ADAMS COUNTY FIRE DEPARTMENT FOR REVIEW AND APPROVAL PRIOR TO CONSTRUCTION.
- 4. INSPECTIONS AND TESTS ON PRIVATE FIRE SERVICE MAINS AND APPURTENANCES SHALL BE IN ACCORDANCE WITH SOUTH ADAMS COUNTY WATER AND SANITATION DISTRICT STANDARDS, NFPA 13 STANDARD, AND NFPA 24 STANDARDS. THE SOUTH ADAMS COUNTY FIRE DEPARTMENT WILL INSPECT AND WITNESS THE INSTALLATION OF THE FIRE SERVICE LINE, THE 2-HOURHYDROSTATIC TEST, AND THE FLUSHING OF THE PIPE. THE SOUTH ADAMS COUNTY WATER AND SANITATION DISTRICT WILL CONDUCT THE CHLORINATION AND CLEAN WATER TEST.

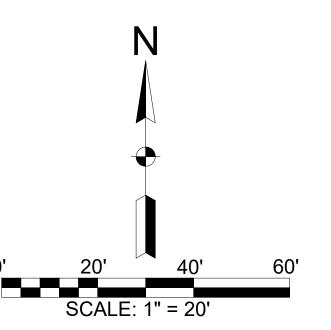

CITY STAFF CERTIFICATE

APPROVED BY THE DEPARTMENT OF COMMUNITY DEVELOPMENT OF COMMERCE CITY, THIS DAY OF ,2022.

DEPARTMENT OF COMMUNITY DEVELOPMENT PIN: 01721000000008

621 SOUTHPARK DR., SUITE 1600 LITTLETON CO, 80120 PHONE: (303) 979-3900 INFO@HABERERGROUP.COM

> Know what's below, Call before you dig.

CALL 811 2-BUSINESS DAYS IN ADVANCE BEFORE YOU DIG, GRADE, OR EXCAVATE FOR THI MARKING OF UNDERGROUND

MEMBER UTILITIES.

REVISIONS: 1.21.22 | 1ST SUB 5.24.23 2ND SUB

HCI 20_01 Project No: Drawn By: ZKA Checked By: 2023-05-24 Date Issued:

Sheet Name: UTILITY PLAN

Number:

PLANT LIST

SYMBOL	KEY	QTY.	BOTANICAL NAME	COMMON NAME	SIZE	NOTES/REMARKS
			STREES		OIZE	
(+ ')	СО	5	Quercus muehlenbergii	Chinkapin Oak	2" cal.	TREES SHALL BE B&B
し ノ			Celtis occidentalis 'Chicagoland'	Chicagoland Hackberry	2" cal.	WITH FULL HEAD &
	HL	3	G. triacanthos inermis 'Shademaster'	Shademaster Honeylocust	2" cal.	STRAIGHT, SINGLE MAIN TRUNK.
	TE	4	Ulmus 'Morton Glossy'	Triumph Elm	2" cal.	WAR TROTUS
<u></u>	ORNA	AMENT	AL TREES			
(+)	СН	5	Crataegus crus-gali inermis 'Crusader'	Crusader Thornless Hawthorn	2" cal.	
	HW	5	Acer tartaricum 'Hot Wings'	Hot Wings Maple	2" cal.	
	EVEF	RGREE	N TREES			
million to the state of the sta	AP	6	Pinus nigra	Austrian Pine	6' Ht.	B&B Full & bushy
>MM.	BP	4	Pinus aristata	Bristlecone Pine	6' Ht.	B&B Full & bushy
	LP	3	Pinus flexilis	Limber Pine	6' Ht.	B&B Full & bushy
	DECI	DUOUS	SHRUBS			
(\cdot)	AA	22	Rhus trilobata 'Autumn Amber'	Autumn Amber Sumac	9-12" ht.	#5 Container
	AF	33	Cornis sericea 'Arctic Fire'	Arctic Fire Redtwig Dogwood	21-24" ht.	#5 Container
	вс	5	Aronia arbutifolia 'Brilliantissima'	Brilliant Red Chokeberry	24-30" ht.	#5 Container
	DL	35	Syringa meyeri 'Miss Kim'	Miss Kim Dwarf Lilac	24-30" ht.	#5 Container
	GL	16	Rhus aromatica 'Gro-Low'	Gro-Low Sumac	15-18" ht.	#5 Container
	HC	15	Symphorocarpus x 'Chenaultii'	Hancock Coralberry	15-18" ht.	#5 Container
	M∨	14	Viburnum lantana 'Mohican'	Mohican Viburnum	36-42" ht.	#5 Container
	NV	8	Viburnum lentago	Nannyberry Viburnum	3-4' ht.	#5 Container
	sw	12	Physocarpus opufolious 'Summer Wine'	Summer Wine Ninebark	30-36" ht.	#5 Container
₹~~ ⁵	EVER	GREE	N SHRUBS			
Z + Z	SJ	7	Juniperus chinensis 'Spartan'	Spartan Juniper	36-42" ht.	#5 Container
	ss	14	Juniperus sabina 'Sierra Spreader'	Sierra Spreader Juniper	9-12" ht.	#5 Container
	ORNA	AMENT.	AL GRASSES			
	ВА	13	Helictotrichon sempervirens	Blue Avena Grass		#5 Container

NOTE: IN THE EVENT OF A DISCREPANCY BETWEEN THE PLAN GRAPHIC AND THE LANDSCAPE PLANT LIST, MATERIAL QUANTITY AS DETERMINED BY THE PLAN GRAPHIC SHALL TAKE PRECEDENCE.

LANDSCAPE SUMMARY (Private property)

	,	1 1 - 7/
LANDSCAPE TREATMENT AREA		Percentage of Total
GROSS SITE AREA: 1.41 AC.		5 Star
a.) Total Landscape Area	24,974 SF	
b.) Irrigated Seeding Area*	1,525 SF	
c.) Area of Dryland Seeding (Det. Pond)	3,375 SF	
d.) Area of Planting Bed	20,074 SF	
e.) Living Plant Material	18,800 SF	75.2%
f.) # Trees Required (1/600 sf)	42	
g.) # Trees Provided	46	
Transplanted	8	
Existing to remain in-place	2	
Proposed	36	
h.) # Shrubs Required (1/300 sf)**	84	
i.) # Shrubs Provided	194	
j.) # of Mulch Types	2	
1	i	1

^{* =} Doesn't include future street expansion seeding area

f.) # of Islands Provided

DETENTION POND

a. Length of perimeter

c.) # Trees Provided

e.) # Shrubs Provided

b.) # Trees Required (1 per 50 LF)

d.) # Shrubs Required (10 per 50 LF)

EXISTING TRANSPLANT TREE SCHEDULE

SYMBOL	KEY	SPECIES	SIZE	SIZE
T-3	T-1	Austrian Pine	8' Ht.	48"
PROPOSED LOCATION	T-2	Austrian Pine	8' Ht.	48"
(3)	T-3	Austrian Pine	12' Ht.	60"
EXISTING	T-4	Austrian Pine	12' Ht.	60"
LOCATION	T-5	Austrian Pine	10' Ht.	60"
	T-6	Austrian Pine	10' Ht.	60"
	T-7	Austrian Pine	8' Ht.	48"
	T-8	Austrian Pine	8' Ht.	48"

REMOVAL / REMAIN IN-PLACE TREE SCHEDULE

QUA.

250 LF

Key	Species	Size	Status	Condition			
A	Siberian Elm	23" cal.	Remove	Poor*			
В	Siberian Elm	6", 13" & 14" cal.	Remove	Poor*			
С	Siberian Elm	40" cal.	Remove	Poor*			
D	Pinyon Pine	12' Ht.	Remain	Poor			
E	Pinyon Pine	10' Ht.	Remain	Poor			
F	Pinyon Pine	10' Ht.	Remove	Poor			
* =	* = Nuisance tree						

MIX #1: PERMANENT DRILL SEEDING MIX

RIGHT-OF-WAY STE	REET TRE	EES		COMMON NAME	BOTANIC NAME	VARIETY	% MIX	# P.L.S. PER AC.
ROW frontage	Length	Required / Provide	ed	BIG BLUESTEM	BOUTELOUA DACTYLOIDES	'KAW'	10%	2.5
a. Rosemary Street	206 LF	5 5		YELLOW INDIANGRASS	BOUTELOUA GRACILIS	'CHEYENNI		2.5
				SWITCHGRASS	PASCOPYRUM SMITHII	'BLACKWEI	L' 10%	2.5
			1	SIDEOATS GRAMA	BOUTELOU CURTIPENDULA	'VAUGHN'	10%	2.5
PARKING LOT LAND	SCAPE A	AREA		WESTERN WHEATGRASS	AGROPYRON SMITHII	'ARRIBA'	10%	2.5
				BLUE GRAMA	BOUTELOUA GRACILIS	'HACITA'	10%	2.5
a.) # Trees Required		6		THICKSPIKE WHEATGRASS	ELYMUS LANCEOLATUS	'CRITANA'	10%	2.5
b.) # Trees Provided		1		PRAIRIE SANDREED	CALAMOVILFA LONGIFOLIA	'GOSHEN'	10%	2.5
•	_1	40 . 750/		GREEN NEEDLEGRASS	NASSELLA VIRIDULA	'LODORM'	10%	2.5
c.) # Shrubs Required	a	12 + 75% screen		SLENDER WHEATGRASS	ELYMUS TRACHYCAULUS	'PRYOR'	5%	1.25
d.) # Shrubs Provided	b	43		STREAMBANK WHEATGRASS	ELYMUS LANCEOLATUS	'SODAR'	5%	1.25
e.) # of Islands Requi	ired	2			TOTAL LBS. PER	ACRE (DRILL	ED)	25.0


MIX #2: DETENTION POND / RIPARIAN SEEDING

COMMON NAME	BOTANIC NAME	VARIETY	% MIX	# P.L.S. PER AC.	
INLAND SALTGRASS	DISTICHLIS STRICTA		15%	2.8	
CREEPING SPIKERUSH	ELEOCHARIS PALUSTRIS		15%	2.8	
BALTIC RUSH	JUNCUS BALTICUS		15%	2.8	
SWITCHGRASS	PANICUM VIRGATUM	'BLACKWELL'	12%	2.3	
GREEN NEEDLEGRASS	NASELLA VIRIDULA		10%	1.9	
PRAIRIE CORDGRASS	SPARTINA PECTINATA		10%	1.9	
WESTERN WHEATGRASS	PASCOPYRUM SMITHII	'ARRIBA'	8%	1.5	
WOOLY SEDGE	CAREX LANUGINOSA		5%	1.0	
NEBRASKA SEDGE	CAREX NEBRASCENSIS		5%	1.0	
TOTAL LBS. PER ACRE (DRILLED) 18.0					

8550 ROSEMARY

A PARCEL OF LAND SITUATED IN THE NORTHWEST 1/4 OF SECTION 28,

TOWNSHIP 2 SOUTH, RANGE 67 WEST OF THE 6TH P.M., CITY OF COMMERCE CITY, COUNTY OF ADAMS, STATE OF COLORADO

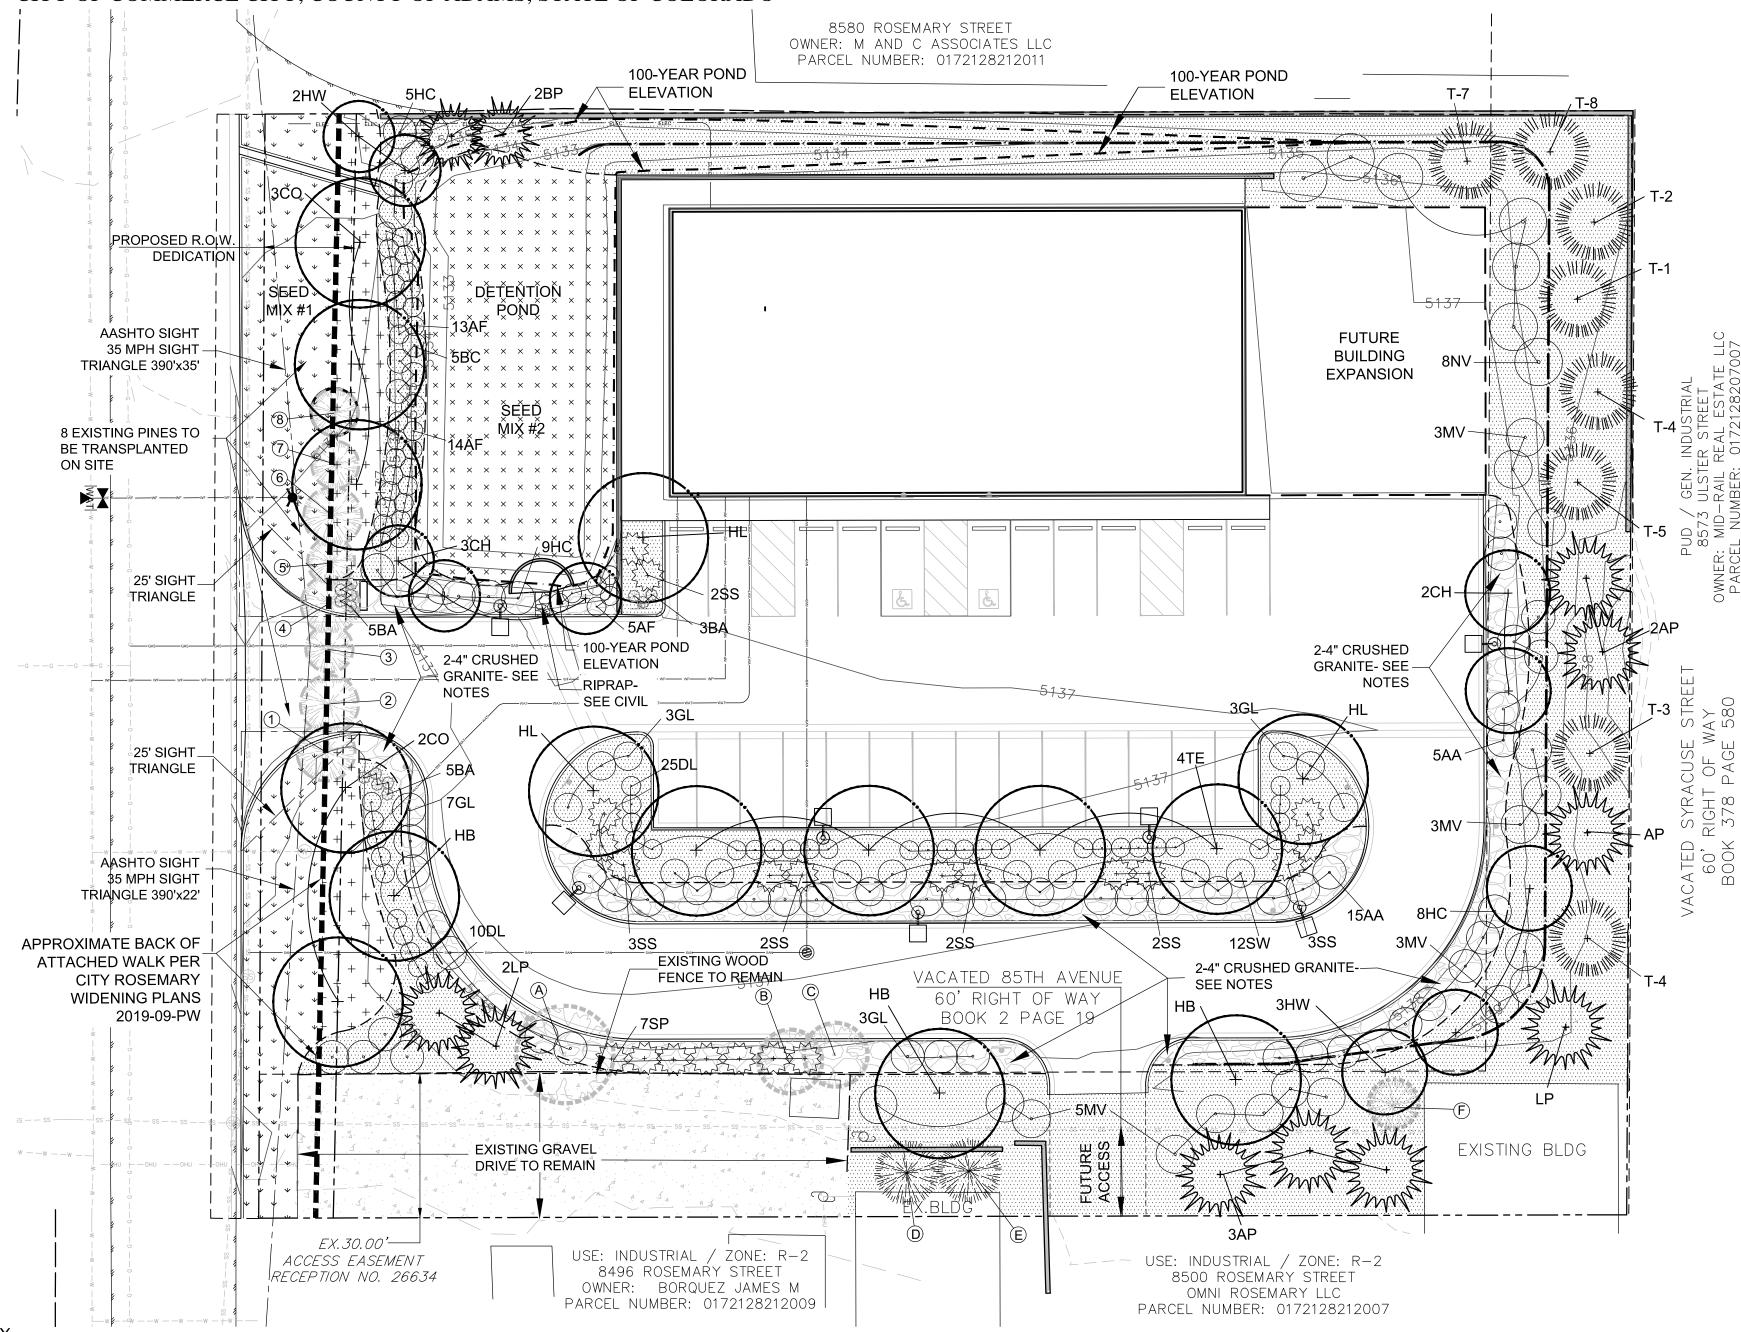

25.0

SITE DATA	
TOTAL SITE AREA:	61,571 SF (1.41 Ac.)
BUILDING COVERAGE	11,540 SF (18.7%)
PAVEMENT	22,059 SF (35.8%)
EXISTING GRAVEL DRIVE	2,998 SF (4.9%)
LANDSCAPE AREA (Private)	24,974 SF (40.6%)
IRRIGATED TURF	1,525 SF (6.1%)
PLANTING BEDS	20,074 SF (80.4%)
DETENTION AREA SEED	3,375 SF (13.5%)
R.O.W EXPANSION AREA	
TEMP. IRRIGATED TURF	3,178 SF

EXISTING DECIDUOUS TREE TO BE REMOVED EXISTING EVERGREEN TREE TO BE REMOVED **EXISTING EVERGREEN** TREE TO BE TRANSPLANTED **EXISTING TRANSPLANT** EVERGREEN AT NEW LOCATION

EXISITING TREE LEGEND

EXISTING DECIDUOUS TREE TO REMAIN

EXISTING EVERGREEN

TREE TO REMAIN

MIX #3: LOW-GROWTH DRILL SEEDING

COMMON NAME	BOTANIC NAME	VARIETY	% MIX	# P.L.S. PER AC.	
CRESTED WHEATGRASS	AGROPYRON CRISTATUM	'EPHRAIM'	30%	7.5	
SHEEP FESCUE	FESTUCA OVINA		25%	6.25	
PERENNIAL RYEGRASS	LOLIUM PERENNE		20%	5.0	
CHEWINGS FESCUE	FESTUCA RUBRA SSP. COMMUTATA		15%	3.75	
CANADA BLUEGRASS	POA COMPRESSA		10%	2.5	
TOTAL LBS. PER ACRE (DRILLED) 25.					


DECIDUOUS TREE ORNAMENTAL TREE **EVERGREEN TREE**

LEGEND

DECIDUOUS SHRUB

ORNAMENTAL GRASS

IRRIGATED TURF SEED MIX #1 DETENTION AREA SEED MIX #2 4" DEPTH ROCK MULCH 2-4" DIA. CRUSHED ROCK R.O.W. EXPANSION AREA EVERGREEN SHRUB NATIVE SEED

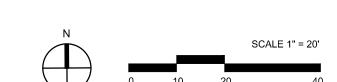

LANDSCAPE EDGER


CITY STAFF CERTIFICATE

APPROVED BY THE DEPARTMENT OF COMMUNITY DEVELOPMENT OF COMMERCE CITY, THIS DAY OF ,2021.

DEPARTMENT OF COMMUNITY DEVELOPMENT

HABERER CARPENTRY INC. 621 SOUTHPARK DR., SUITE 1600

> LITTLETON CO, 80120 PHONE: (303) 979-3900

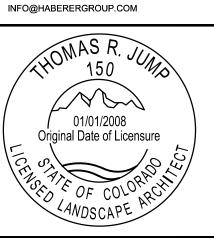



info@jumpdesignco.com 303.282.0463 Know what's **below**, Call before you dig.

1733 S. Clarkson Street Denver, Colorado 80210

CALL 811 2-BUSINESS DAYS IN ADVANCE BEFORE YOU DIG, GRADE, OR EXCAVATE FOR THE MARKING OF UNDERGROUND MEMBER UTILITIES.

8550 ROSEMACITY OF COMMERCE COUNTY OF ADAMS

REV	REVISIONS:					
No.	Date:	Description:				
1	05.08.23	CITY COMMENTS				

HCI 20 01 Project No: Drawn By: JDC Checked By: TJ 01.21.22 Date Issued: Sheet Name: Landscape Plan

Number:

^{** =} Includes detention pond, parking & 75% cover req's.

8550 ROSEMARY

A PARCEL OF LAND SITUATED IN THE NORTHWEST 1/4 OF SECTION 28,

TOWNSHIP 2 SOUTH, RANGE 67 WEST OF THE 6TH P.M., CITY OF COMMERCE CITY, COUNTY OF ADAMS, STATE OF COLORADO

PLAN NOTES

1. ALL WORK SHALL CONFORM TO THE CITY OF COMMERCE CITY STANDARDS & REGULATIONS.

2. CONTACT APPROPRIATE UTILITY LOCATORS TO LOCATE OF ALL BURIED UTILITY LINES. FIELD-VERIFY EXISTING LOCATIONS, GRADES, AND CONDITIONS OF ALL BURIED UTILITIES PRIOR TO CONSTRUCTION. NOTIFY OWNER'S REPRESENTATIVE OF ANY CONFLICTS OR DISCREPANCIES FROM THESE PLANS. DAMAGE TO UTILITIES BY THE CONTRACTOR SHALL BE REPAIRED AT HIS OWN COST WITH NO EXPENSE TO THE OWNER.

3. VERIFY THE LOCATION OF ALL PERTINENT EXISTING & CONSTRUCTED SITE IMPROVEMENTS ALREADY INSTALLED PRIOR TO BEGINNING WORK. NOTIFY THE OWNER'S REPRESENTATIVE OF ANY CONFLICTS OR DISCREPANCIES FROM THE INFORMATION SHOWN ON THESE PLANS. IF DISCREPANCIES EXIST DO NOT PROCEED WITH CONSTRUCTION ACTIVITIES WITHOUT APPROVAL OF THE OWNER'S REPRESENTATIVE.

4. REFER TO THE ARCHITECTURAL, ENGINEERING, ELECTRICAL AND IRRIGATION PLANS COMPLETED BY OTHERS. ANY DISCREPANCIES THAT AFFECT THIS WORK MUST BE BROUGHT TO THE ATTENTION OF THE OWNER'S REPRESENTATIVE PRIOR TO CONSTRUCTION.

5. REFER TO THE CONSTRUCTION DRAWINGS DONE BY OTHER CONSULTANTS FOR GRADING AND ELEVATIONS. ENSURE POSITIVE DRAINAGE (2% MIN. FALL) AWAY FROM ALL BUILDING FOUNDATIONS IN ALL LANDSCAPE AREAS, NOTIFY OWNER'S REPRESENTATIVE IF ROUGH GRADING CONDITIONS WILL CREATE PONDING OR FLOW TOWARD FOUNDATIONS. ROUGH GRADES SHALL BE REVIEWED AND ACCEPTED BY OWNER'S REPRESENTATIVE PRIOR TO FINE GRADING AND SOIL PREPARATION OPERATIONS.

6. COORDINATE LOCATION OF IRRIGATION SLEEVING FOR INSTALLATION PRIOR TO PARKING AND WALK PAVING OPERATIONS. SEE IRRIGATION PLANS.

FINE GRADING / PREPARATION NOTES

7. LANDSCAPE OPERATIONS SHALL ACHIEVE FINISHED GRADES AS SHOWN ON THE CIVIL GRADING PLANS AFTER INSTALLATION. ALL COMPLETED LANDSCAPE AREAS SHALL DRAIN AT 2% MINIMUM SLOPE WITHOUT LOW SPOTS THAT POND. FINISH GRADES SHALL SLOPE AWAY FROM STRUCTURES AT THE RECOMMENDED SLOPES INDICATED IN THE PROJECT GEOTECHNICAL/ SOILS REPORT UNLESS SPECIFICALLY APPROVED BY THE CIVIL ENGINEER AND OWNER.

8. THE LANDSCAPE CONTRACTOR SHALL REVIEW THE COMPLETED ROUGH GRADING OPERATIONS PRIOR TO BEGINNING WORK AND NOTIFY THE OWNER'S REPRESENTATIVE OF ANY DISCREPANCIES BETWEEN THE GRADING PLANS AND ACTUAL CONDITIONS.

9. ALL LANDSCAPE AREAS SHALL BE FINE GRADED TO .10" +/- RESULTING IN A SMOOTH FINISH WITHOUT DEBRIS, DELETERIOUS MATERIALS OR CLODS OVER 1" DIAMETER. ALL FINE GRADING MUST BE APPROVED BY THE OWNER'S REPRESENTATIVE PRIOR TO LANDSCAPE INSTALLATION.

10. TO THE MAXIMUM EXTENT FEASIBLE, TOPSOIL THAT IS REMOVED DURING CONSTRUCTION ACTIVITY SHALL BE CONSERVED FOR LATER USE ON AREAS REQUIRING REVEGETATION AND LANDSCAPING. COORDINATE WITH GENERAL CONTRACTOR, THE TOP 4" OF LANDSCAPE AREAS SHALL BE EXISTING OR IMPORTED TOPSOIL AS NECESSARY.

11. SOIL AMENDMENT SHALL BE LOW-SALTS, FULLY-MATURED & NITROGEN STABILIZED ORGANIC COMPOST, CERTIFIED FREE OF PATHOGENS. pH SHALL BE 6.0 TO 7.4 WITH A MIN. OF 30% ORGANIC MATERIAL, COMPOST SHALL BE BIOCOMP-CLASS 1 BY A1 ORGANICS 16350 WCR 76, EATON, CO 80615, OR APPROVED EQUAL. AMENDMENT FOR LANDSCAPE AREAS SHALL BE 4 C.Y. PER 1,000 S.F.

12. THE TOP 5" OF SUBGRADE SHALL BE TOPSOIL AND SOIL AMENDMENT MIXTURE TILLED TO A MIN. DEPTH OF 6" BELOW SUBGRADE.

13. IN ALL BED AREAS HOLD TOP OF SUBGRADE 3-4" BELOW ADJACENT IMPROVEMENTS TO ALLOW FOR SPECIFIED MULCH DEPTH.

PLANTING NOTES

14. PLANTS SHALL SHALL BE TRUE TO TYPE & SPECIES, HAVE SIMILAR SIZE & FORM AMONG THE SAME SPECIES AND MEET THE MINIMUM STANDARDS OUTLINED IN THE "AMERICAN STANDARD FOR NURSERY STOCK" ANSI Z60.1 (2014).

15, ALL PLANT MATERIALS SHALL BE HEALTHY. FREE OF PESTS. DISEASES AND BROKEN CONTAINERS AND ROOT BALLS. TREES SHALL HAVE SINGLE LEADERS UNLESS OTHERWISE SPECIFIED AND ROBUST BRANCHING AND FOLIAGE. ALL PLANTS ARE ARE SUBJECT TO APPROVAL BY THE OWNER'S REPRESENTATIVE- PLANTS NOT MEETING THE SET STANDARDS WILL BE

16. PLANT SPECIES AND LOCATIONS SHOULD FOLLOW THE APPROVED PLAN. IF SITE CONDITIONS OR PLANT AVAILABILITY REQUIRE CHANGES TO THE PLAN, THE CONTRACTOR MUST OBTAIN APPROVAL FROM THE CITY AND THE OWNER'S REPRESENTATIVE. SUBSTITUTIONS SHALL BE SUBMITTED PRIOR TO BIDDING AND REQUESTED SPECIES SHALL MATCH THE SPECIFIED PLANT'S MATURE SIZE & FORM.

17. ALL PLANT MATERIAL SHALL CARRY A WARRANTY FOR A PERIOD OF NOT LESS THAN 1 YEAR AFTER ACCEPTANCE OF THE PROJECT BY THE OWNER. WARRANTY SHALL BE A ONE-TIME, POST-FINAL ACCEPTANCE REPLACEMENT THAT INCLUDES PLANT MATERIAL AND LABOR COSTS. PLANTS NEEDED REPLACED PRIOR TO ACCEPTANCE WILL NOT APPLY TOWARD WARRANTY

18. LAYOUT PLANT LOCATIONS FOR APPROVAL PRIOR TO INSTALLATION. TREE LOCATIONS SHALL BE NO CLOSER THAN 3' FROM ALL CURBS & WALKWAYS EXCEPT FOR PARKING ISLANDS.

19. PLANT QUANTITIES SHOWN SYMBOLICALLY ON THE PLAN SHALL TAKE PRECEDENT AND BE INSTALLED OVER THOSE TOTALS IN THE PLANT LIST.

20. PLANT HOLE BACKFILL SHALL BE 1/3 TOPSOIL, 1/3 COMPOSTED AMENDMENT AND 1/3 NATIVE SOIL THOROUGHLY MIXED.

21. ALL SHRUBS & GRASSES SHALL RECEIVE SCOTT'S AGRIFORM SLOW-RELEASE FERTILIZER TABLETS APPLIED AT MANUFACTURER RECOMMENDED RATES.

22. LAYOUT BED LINES FOR APPROVAL PRIOR TO INSTALLATION. ALL PLANTING BEDS ARE TO BE CONTAINED WITH MINIMUM 4" HEIGHT STEEL EDGER WITH ROLLED TOP AND NO EXPOSED SHARP EDGES. EDGER SHALL BE EXPOSED 1/2" MAXIMUM ABOVE FINISHED SURFACES. EDGER IS NOT REQUIRED WHEN ADJACENT TO CURBS, WALLS OR WALKS.

23. EDGER SHALL BE PRO-STEEL PS3/16-16, 4" DEPTH x 3/16" (7 GA.) WITH STAKES AND FASTENED OVERLAP SECTIONS PER MANUFACTURER'S RECOMMENDATIONS. SUPPLIER SHALL BE PRO-STEEL EDGING & LANDSCAPE PRODUCTS, 5121 KALTENBRUN RD., FORT WORTH, TX 76119 OR APPROVED

WEED BARRIER & MULCH

24. INSTALL DEWITT PRO-5 WEED BARRIER FABRIC OR APPROVED EQUAL UNDER ALL ROCK BEDS. DO NOT INSTALL WEED BARRIER BELOW SHREDDED RED CEDAR WOOD MULCH BEDS.

25. PLANTING BEDS SHALL BE MULCHED WITH:

A. 1.5" DIAMETER CRUSHED ROCK MULCH, 'COLORADO RED' AND

B. 2-4" DIAMETER GRAY AGGREGATE

FROM BEDROCK MATERIALS, 5401 W 52ND AVE., DENVER CO 80212 303-432-7222 OR APPROVED EQUAL OVER LANDSCAPE FILTER FABRIC, MIRAFI 140N, SUBMIT SAMPLE TO OWNER'S REPRESENTATIVE FOR APPROVAL PRIOR TO INSTALLATION.

26. ALL PLANTS IN ROCK MULCH BEDS SHALL HAVE 3-4" DEPTH RING OF DOUBLE-SHREDDED RED CEDAR MULCH ABOVE EACH PLANTING PIT AT 1.5 TIMES THE CONTAINER DIAMETER. MULCH & ROCK COLOR SHALL BE APPROVED BY OWNER PRIOR TO INSTALLATION.

27. TREES IN SEEDED OR SODDED AREAS SHALL ALSO HAVE DOUBLE-SHREDDED RED CEDAR MULCH RINGS OF AT LEAST 3-4' IN DIAMETER.

IRRIGATION

28. IRRIGATION SHALL INSTALLED PER PLANS APPROVED BY THE CITY AND BE AN UNDERGROUND AUTOMATIC SYSTEM WITH ELECTRIC CONTROLLER AND RAIN SENSOR. PLANT BEDS SHALL BE IRRIGATED BY DRIP EMITTERS AND TURF AREAS SHALL BE WATERED BY SPRAY HEADS OR ROTORS.

SEEDING NOTES:

-AREA OF SEEDING AND MULCHING.

- TYPE OF SEED MIX (PERMANENT, TEMPORARY, OR LOW-GROWTH).

2. SEEDED NATIVE TURF AREAS SHALL BE DRILL SEEDED WITH TACKIFIER PER THE SEED MIX LISTED ON THE PLAN. SOIL PREPARATION & FINE GRADING SHALL BE INSTALLED & PERFORMED AS SPECIFIED PRIOR TO BEGINNING SEEDING; IRRIGATION SHALL BE OPERABLE PRIOR TO BEGINNING SEEDING OPERATIONS. DO NOT SEED ON FROZEN GROUND.

3. ALL BRANDS FURNISHED SHALL BE FREE FROM SUCH NOXIOUS SEEDS AS RUSSIAN OR CANADIAN THISTLE, COARSE FESCUE, EUROPEAN BINDWEED, JOHNSON GRASS, KNAP WEED AND LEAFY SPURGE.

4. THE SEEDER SHALL FURNISH TO THE CONTRACTOR A SIGNED STATEMENT CERTIFYING THAT THE SEED FURNISHED IS FROM A LOT THAT HAS BEEN TESTED BY A RECOGNIZED LABORATORY. SEED WHICH HAS BECOME WET, MOLDY, OR OTHERWISE DAMAGED IN TRANSIT OR IN STORAGE WILL NOT B ACCEPTABLE. SEED TICKETS SHALL BE PROVIDED TO THE CITY UPON REQUEST.

5. DRILL SEEDING MIX SHALL CONFORM TO THE APPROPRIATE MIX AS SHOWN ON THE PLANS.

6. IF THE SEED AVAILABLE ON THE MARKET DOES NOT MEET THE MINIMUM PURITY AND GERMINATION PERCENTAGES SPECIFIED, THE SUBCONTRACTOR MUST COMPENSATE FOR A LESSER PERCENTAGE OF PURITY OR GERMINATION BY FURNISHING SUFFICIENT ADDITIONAL SEED TO EQUAL THE SPECIFIED PRODUCT. THE TAGS FROM THE SEED MIXES MUST BE SUPPLIED TO CONTRACTOR AND FORWARDED TO THE CITY INSPECTOR.

7. THE FORMULA USED FOR DETERMINING THE QUANTITY OF PURE LIVE SEED (PLS) SHALL BE (POUNDS OF SEED) X (PURITY) X (GERMINATION)= POUNDS OF PURE LIVE SEED (PLS).

8. ALL AREAS TO BE SEEDED AND MULCHED SHALL HAVE NATIVE TOPSOIL OR APPROVED SOIL AMENDMENTS SPREAD TO A DEPTH OF AT LEAST 6 INCHES (LOOSE DEPTH). HAUL ROADS AND OTHER COMPACTED AREAS SHALL BE LOOSENED TO A DEPTH OF 8 INCHES PRIOR TO SPREADING TOPSOIL.

9. SOIL IS TO BE THOROUGHLY LOOSENED (TILLED) TO A DEPTH OF AT LEAST 8 INCHES PRIOR TO SEEDING. THE TOP 8 INCHES OF THE SEED BED SHALL BE FREE OF ROCKS GREATER THAN 4 INCHES AND SOIL CLODS GREATER THAN 2 INCHES. SEEDING OVER ANY COMPACTED AREAS THAT HAVEN'T BEEN THOROUGHLY LOOSENED SHALL BE REJECTED.

10. SEED IS TO BE APPLIED USING A MECHANICAL DRILL TO A DEPTH OF 1/4 INCH. ROW SPACING SHALI BE NO MORE THAN 6 INCHES. MATERIAL USED FOR MULCH SHALL CONSIST OF LONG-STEMMED STRAW, AT LEAST 50 PERCENT OF THE MULCH, BY WEIGHT, SHALL BE 10 INCHES OR MORE IN LENGTH MULCH SHALL BE APPLIED AND MECHANICALLY ANCHORED TO A DEPTH OF AT LEAST 2 INCHES. MULCH SHALL BE APPLIED AT A RATE OF 4000 LB. OF STRAW PER ACRE.

11. IF THE CONTRACTOR DEMONSTRATES THAT IT IS NOT POSSIBLE TO DRILL SEED, SEED IS TO BE UNIFORMLY BROADCAST AT TWO TIMES THE DRILLED RATE, THEN LIGHTLY HARROWED TO PROVIDE A SEED DEPTH OF APPROXIMATELY 1-1/4 INCH, THEN ROLLED TO COMPACT, THEN MULCHED AS SPECIFIED ABOVE.

12. SEEDING AND MULCHING SHALL BE COMPLETED WITHIN 30 DAYS OF INITIAL EXPOSURE OR 7 DAYS AFTER GRADING IS SUBSTANTIALLY COMPLETE IN A GIVEN AREA (AS DEFINED BY THE CITY. THIS MAY REQUIRE MULTIPLE MOBILIZATIONS FOR SEEDING AND MULCHING.

13. HYDROMULCH SHALL BE APPLIED WITHIN 24-HOURS OF SEEDING. SEEDING SHALL RECEIVE & BE COVERED WITH A HYDRO-SLURRY MIX AS FOLLOWS:

- CELLULOSE/ WOOD FIBER MULCH @ 46 LBS PER 1000 SF - 15-15-15 GRANULAR ORGANIC FERTILIZER @ 9 LBS PER 1000 SF
- ORGANIC TACKIFIER/ BINDER @ 4 LBS PER 1000 SF
- 14. SLOPES 3:1 to 2.5:1 SHALL BE COVERED WITH NORTH AMERICAN GREEN S150 EROSION CONTROL

MAT OR APPROVED EQUAL. NORTH AMERICAN GREEN, 5401 ST WENDEL CYNTHIANA RD, POSEYVILLE, IN 47633 (812) 963-3373.

SEEDING AND MULCHING MAINTENANCE NOTES:

METHOD SHALL BE APPROVED BY THE CITY.

. SEEDED AND MULCHED AREAS SHALL BE INSPECTED FOR REQUIRED COVERAGE MONTHLY THROUGHOUT THE WARRANTY PERIOD FOLLOWING INITIAL SEEDING. REPAIRS AND RE-SEEDING AND MULCHING SHALL BE UNDERTAKEN AFTER THE FIRST GROWING SEASON FOR ANY AREAS FAILING TO

2. REQUIRED COVERAGE FOR STANDARD, OPEN SPACE AND LOW GROWTH SEED MIXES SHALL BE


- a. THREE (3) PLANTS PER SQUARE FOOT WITH A MINIMUM HEIGHT OF 3 INCHES. THE 3 PLANTS PER SQUARE FOOT SHALL BE OF THE VARIETY AND SPECIES FOUND IN THE CITY APPROVED MIX. b. NO BARE AREAS LARGER THAN 4 SQUARE FEET (TWO-FEET BY "TWO-FEET OR EQUIVALENT). c. FREE OF ERODED AREAS.
- d. FREE FROM INFESTATION OF NOXIOUS WEEDS IN ACCORDANCE WITH SECTION 6.4 OF THE GESC CRITERIA MANUAL.

3. REQUIRED COVERAGE FOR TURF GRASS AREAS SHALL BE DEFINED AS FOLLOWS: a. AT LEAST 80% VEGETATIVE COVER OF GRASS SPECIES PLANTED.


- b. NO BARE AREAS LARGER THAN 4 SQUARE FEET (TWO-FEET BY "TWO-FEET OR EQUIVALENT). c. FREE OF ERODED AREAS.
- d. FREE FROM INFESTATION OF NOXIOUS WEEDS IN ACCORDANCE WITH SECTION 6.4 OF THE GESC CRITERIA MANUAL.
- 4. RILL AND GULLY EROSION SHALL BE FILLED WITH TOPSOIL PRIOR TO RESEEDING. THE RESEEDING

NOTE: CONTRACTOR SHALL PROVIDE ADEQUATE MOISTURE VIA HAND-WATERING OR OTHER METHOD

TO GERMINATE AND ESTABLISH NATIVE TURF AREAS FOR ACCEPTANCE AS DESCRIBED ABOVE.

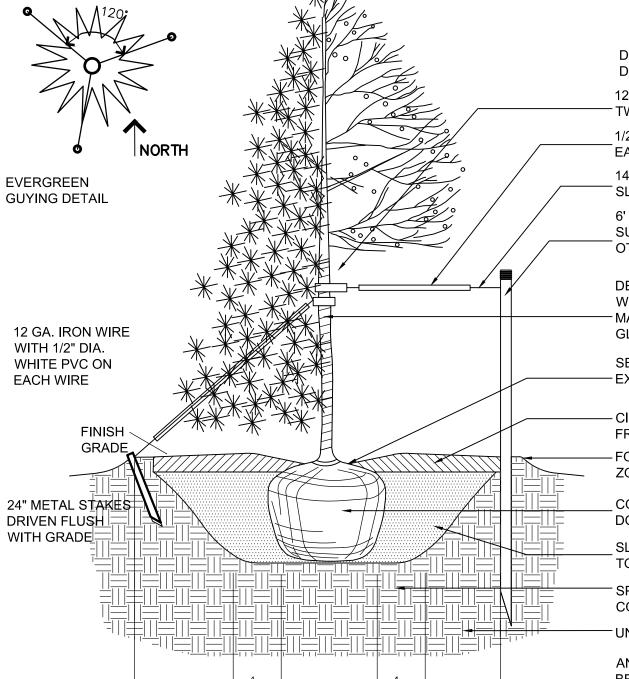

DO NOT CUT SINGLE LEADER. PRUNE ONLY DAMAGED. DEAD WOOD, OR CO-DOMINANT LEADERS. 12" NYLON TREE STRAP WITH GROMMETS ON GUY WIRE. DO NOT TWISTS STRAPS TO TIGHTEN AROUND TRUNK. 1/2" DIAMETER WHITE PVC PIPE SECTION ON ENTIRE LENGTH OF EACH WIRE. 14-GAUGE GALVANIZED WIRE, DOUBLE STRAND. LEAVE 1-2" SLACK IN WIRE TO ALLOW FOR TRUNK MOVEMENT. 6' STEEL T-POST OR WOOD STAKE (4' EXPOSED, 2' IN UNDISTURBED SUBGRADE) WITH SAFETY CAPS, SET TO WINDWARD SIDE AND OTHER OPPOSITE; OR OTHER PRE-APPROVED STAKING METHOD. DECIDUOUS TREE FALL PLANTING: WRAP TRUNK TO FIRST BRANCH WITH SPECIFIED TREE WRAP MATERIAL. SECURE AT TOP WITH - MASKING TAPE. DO NOT WRAP ROUGH BARK, POPULUS, OR GLEDITSIA TREES. REMOVE IN SPRING AS SPECIFIED. SET ROOT COLLAR 2 TO 3" HIGHER THAN FINISHED GRADE. REMOVE -EXCESS SOIL FROM TOP OF ROOT BALL. - CIRCLE OF SHREDDED WOOD MULCH, 3" DEEP AND 4-6" AWAY FROM TRUNK, TO OUTER EDGE OF PLANTING HOLE. - FORM 2" HIGH DIRT SAUCER AROUND PIT AT OUTSIDE OF TRANSITION COMPLETELY REMOVE ALL TWINE AND WIRE BASKET. PULL BURLAP DOWN MINIMUM OF 2/3, CUT AND REMOVE FROM PIT. SLOPE SIDES OF PLANTING PIT AS SHOWN, ROUGHEN SIDES PRIOR TO BACKFILL. SPECIFIED BACKFILL MIXTURE (1/3 NATIVE SOIL, 1/3 TOPSOIL, 1/3 COMPOSTED AMENDEMENT) UNDISTURBED SUBGRADE ANY BROKEN, CRUMBLING, OR OTHERWISE DAMAGED ROOTBALL WILL BE REJECTED. DAMAGE DURING PLANTING OPERATIONS WILL NOT BE PRIOR TO DIGGING, THE UTILITY NOTIFICATION CENTER OF COLORADO SHALL BE CONTACTED AT 811 TO LOCATE -----3-4 X Root Ball Diameter -----UNDERGROUND UTILITIES.

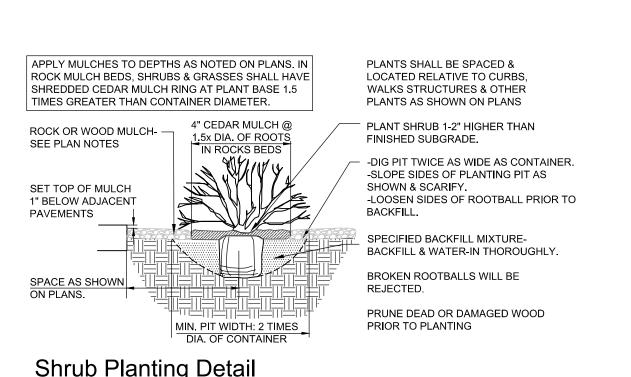

NOT TO SCALE

Typical Tree Planting Detai

SPECIFIED MULCH DEPTH W/ WEED BARRIER TURF AS SPECIFIED


1/4" THICKNESS x 4" DEPTH STEEL EDGING WITH ROLLED PROTECTIVE TOP OR APPROVED EQUAL INSTALL EDGING AS RECOMMENDED

BY MANUFACTURER

SET ALL EDGING 1" ABOVE FINISH GRADE AS SHOWN. EDGING SHALL ABUT ALL CONCRETE CURBS AND WALKS PERPENDICULAR, AND FLUSH W/ GRADES OF CONCRETE. ALL JOINTS TO BE SECURELY STAKED.

Edger NOT TO SCALE

FINISH GRADE 1" BELOW TOP OF

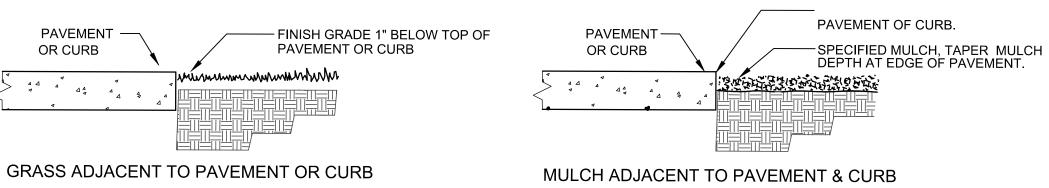

Typical Landscape Edges

PAVEMENT

OR CURB

CITY STAFF CERTIFICATE


APPROVED BY THE DEPARTMENT OF COMMUNITY DEVELOPMENT OF COMMERCE CITY, THIS DAY OF

DEPARTMENT OF COMMUNITY DEVELOPMENT

A DIVISION OF HABERER CARPENTRY INC. 621 SOUTHPARK DR., SUITE 1600 LITTLETON CO, 80120 PHONE: (303) 979-3900

INFO@HABERERGROUP.COM

riginal Date of Licensure

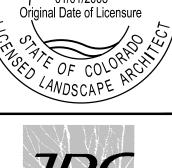

Jump Design Compan 1733 S. Clarkson Street

Denver, Colorado 80210

info@iumpdesianco.com

303.282.0463

Know what's **below**,



CALL 811 2-BUSINESS DAYS IN ADVANCE BEFORE YOU DIG, GRADE, OR EXCAVATE FOR THE MARKING OF UNDERGROUND MEMBER UTILITIES.

0

REVISIONS: No. Date: Description: 05.08.23 CITY COMMENTS Project No:


Drawn By: JDC Checked By:


> 01.21.22 Sheet Name Landscape Details

Number:

Date Issued:

A PARCEL OF LAND SITUATED IN THE NORTHWEST 1/4 OF SECTION 28, TOWNSHIP 2 SOUTH, RANGE 67 WEST OF THE 6TH P.M., CITY OF COMMERCE CITY, COUNTY OF ADAMS, STATE OF COLORADO

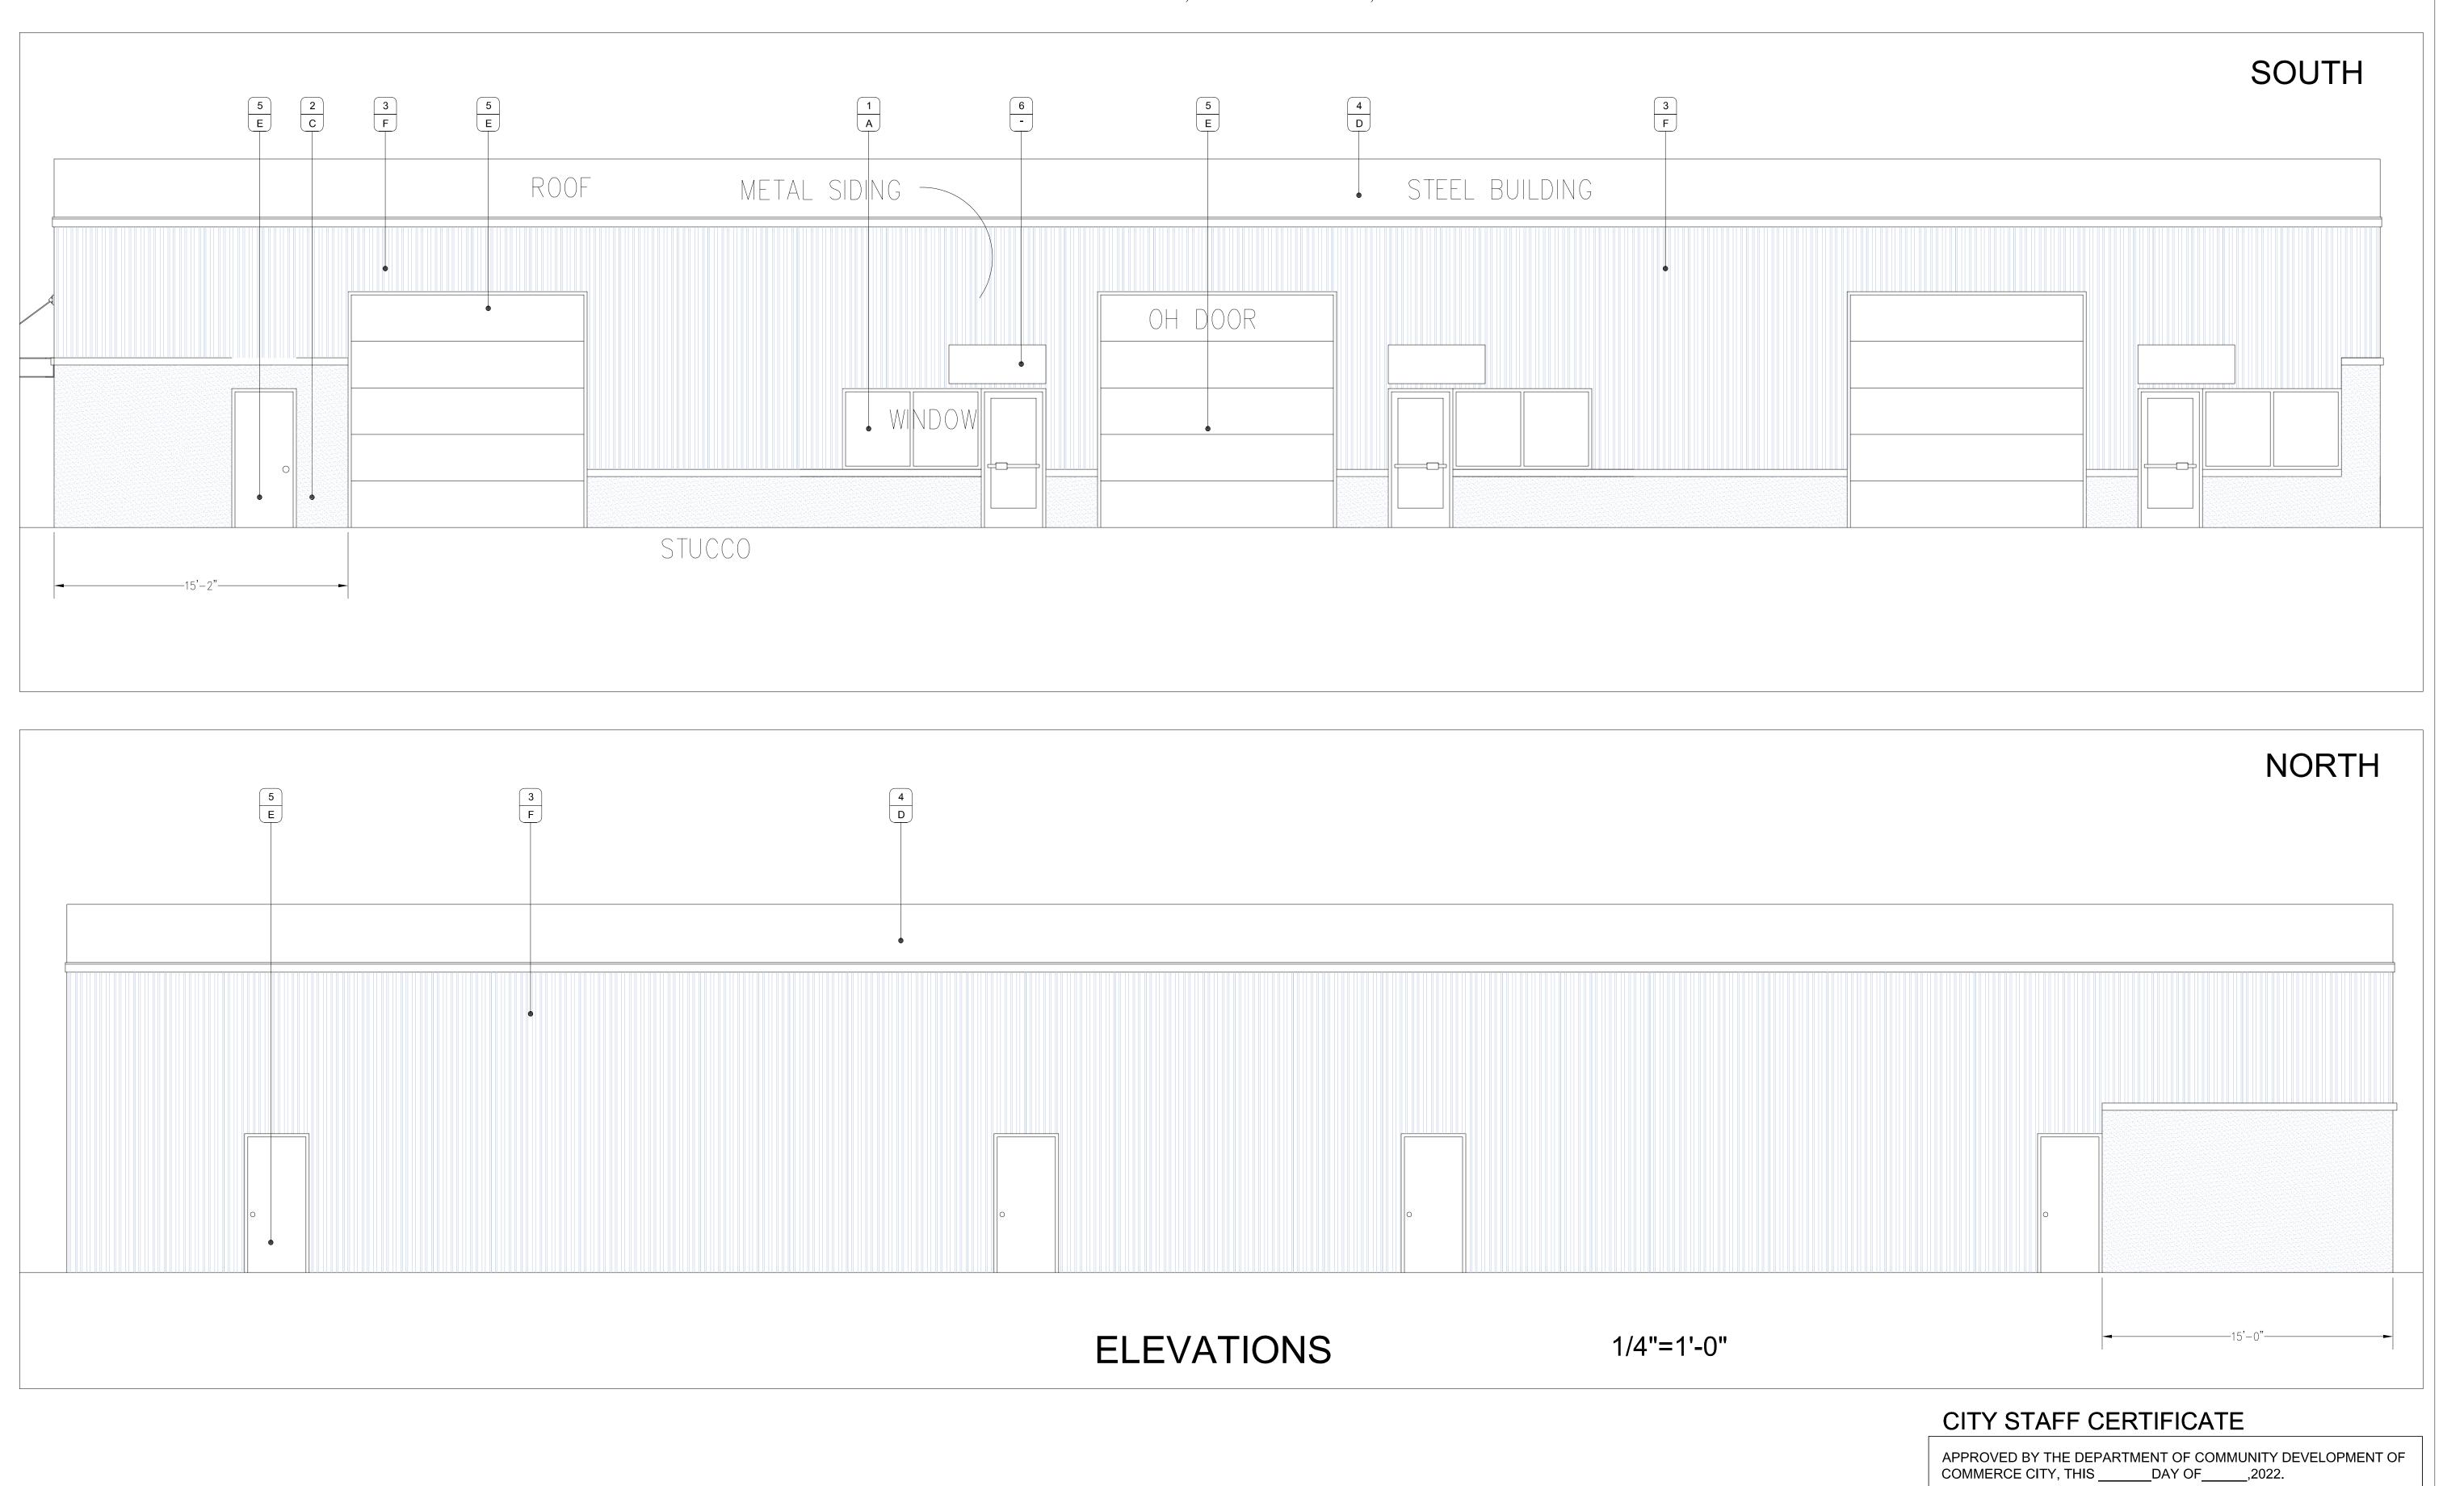

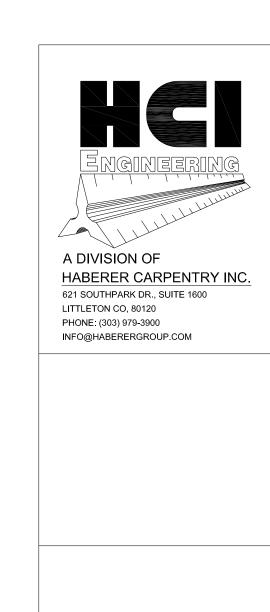



REVISIONS: No. Date: Description: 1 | 1.21.22 | 1ST SUB 2 4.14.23 2ND SUB HCI 20_01 Checked By:


Date Issued: 2023-04-20 Sheet Name:


Sheet Number:


DEPARTMENT OF COMMUNITY DEVELOPMENT

PIN: 01721000000008


A PARCEL OF LAND SITUATED IN THE NORTHWEST 1/4 OF SECTION 28, TOWNSHIP 2 SOUTH, RANGE 67 WEST OF THE 6TH P.M., CITY OF COMMERCE CITY, COUNTY OF ADAMS, STATE OF COLORADO

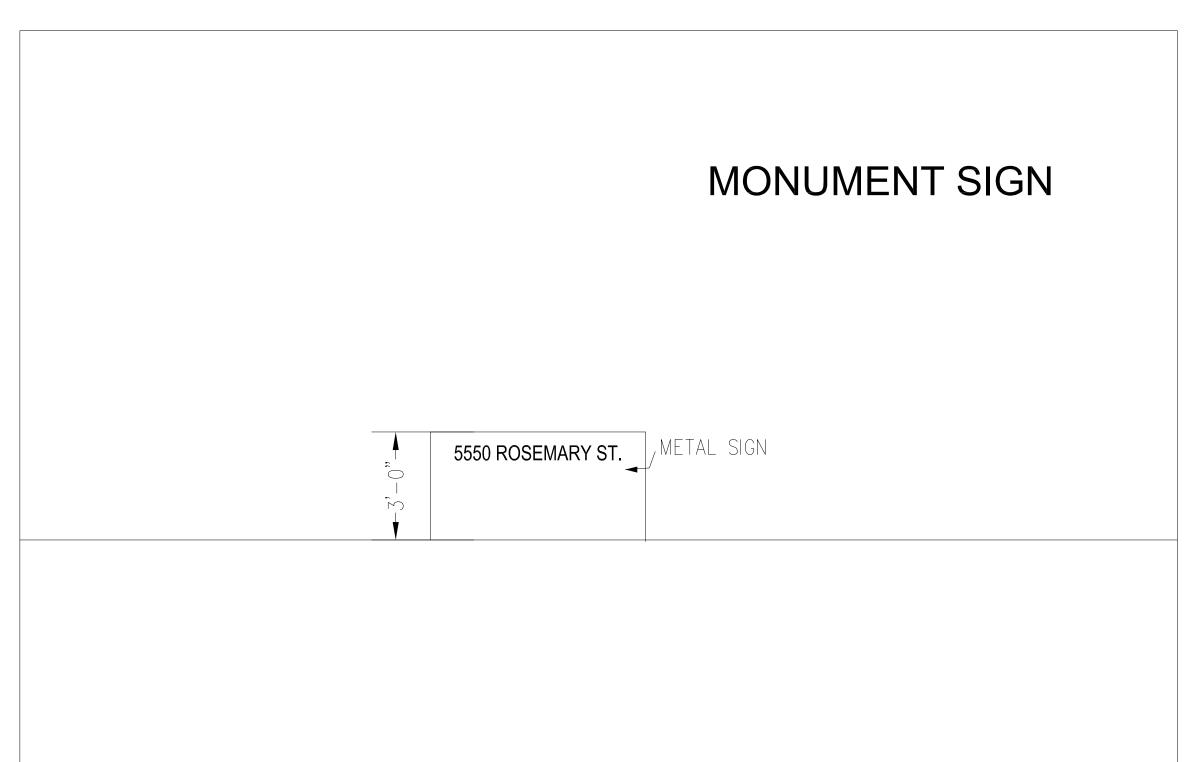

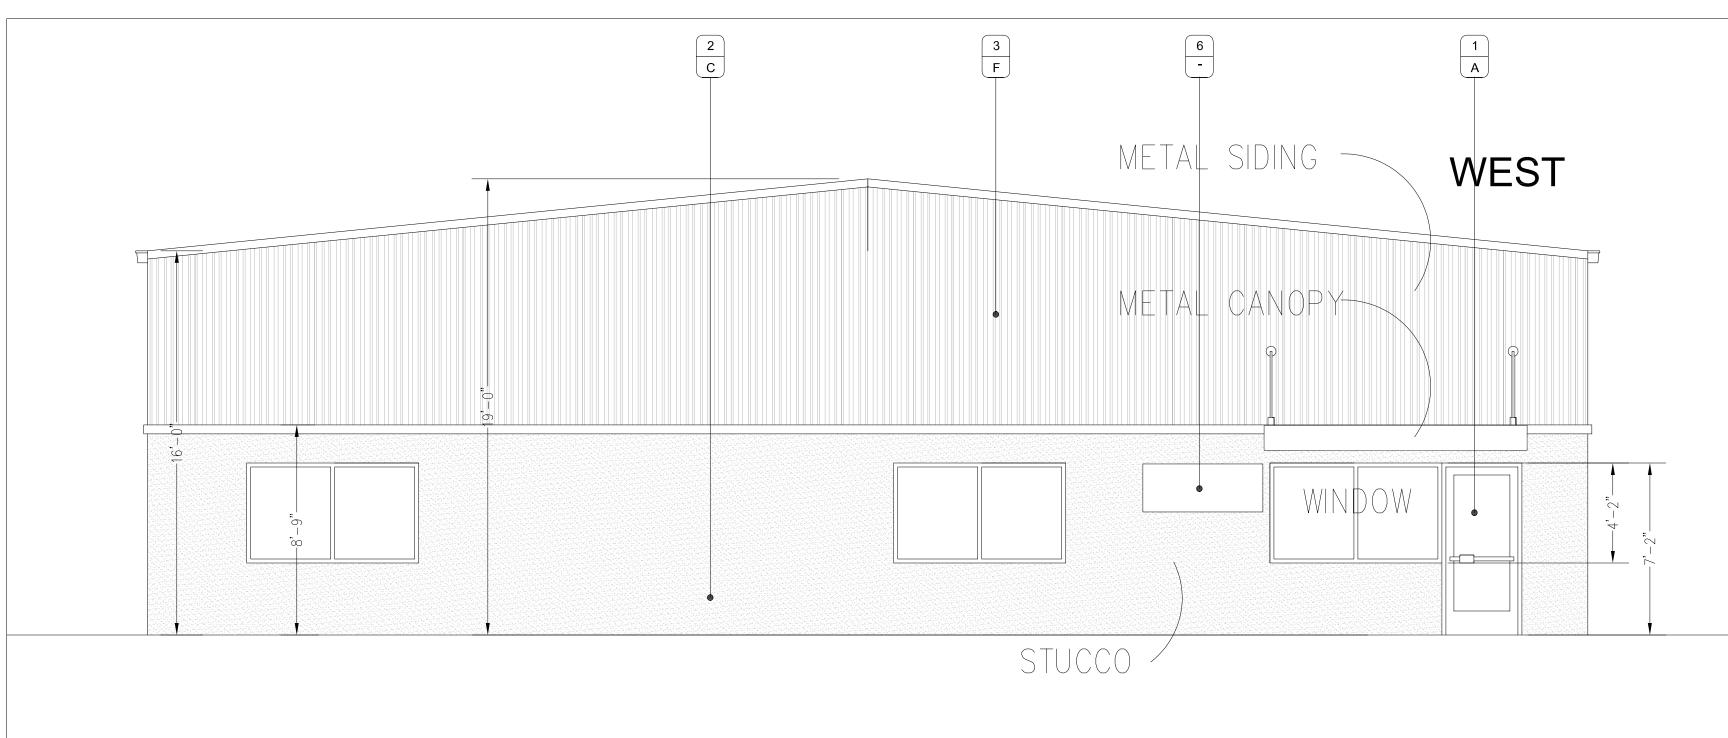

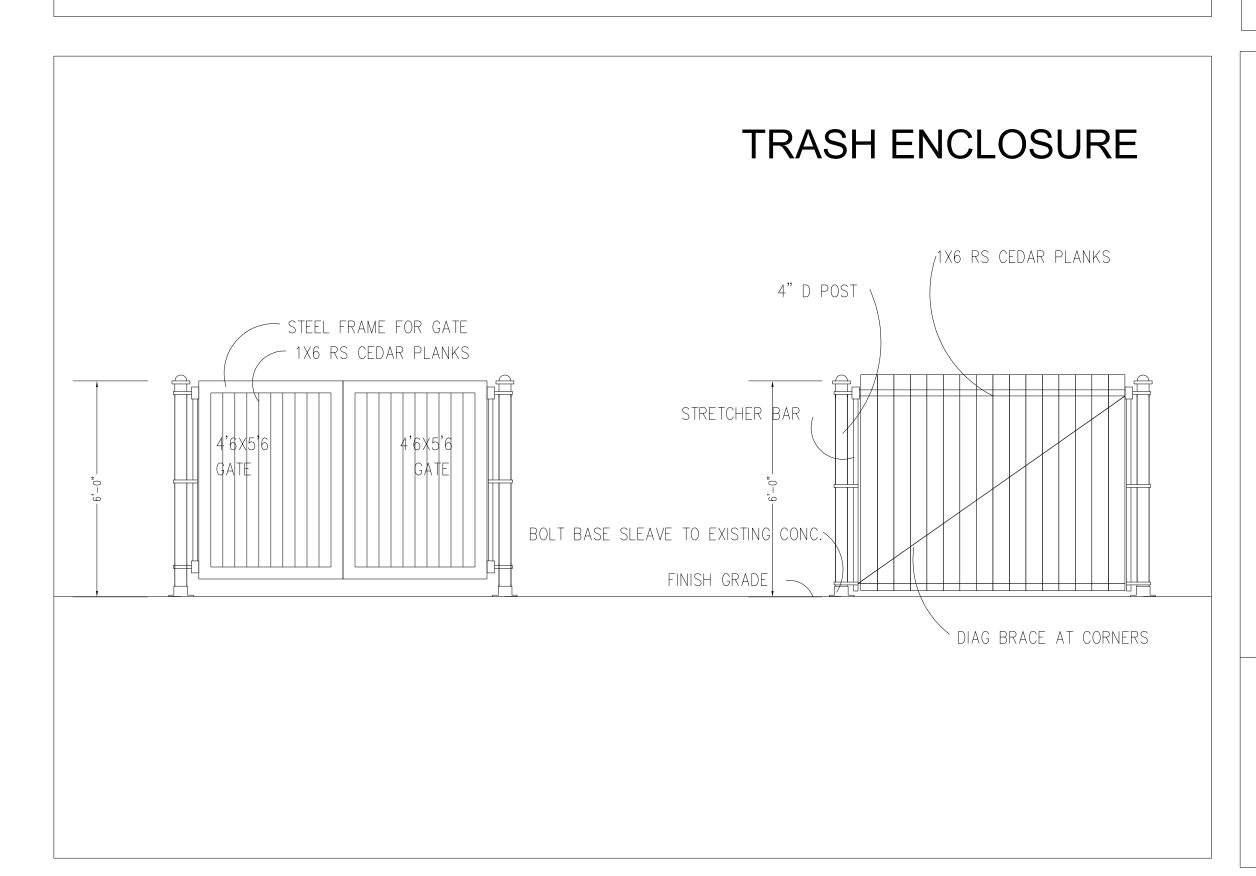

3/8"=1'-0"

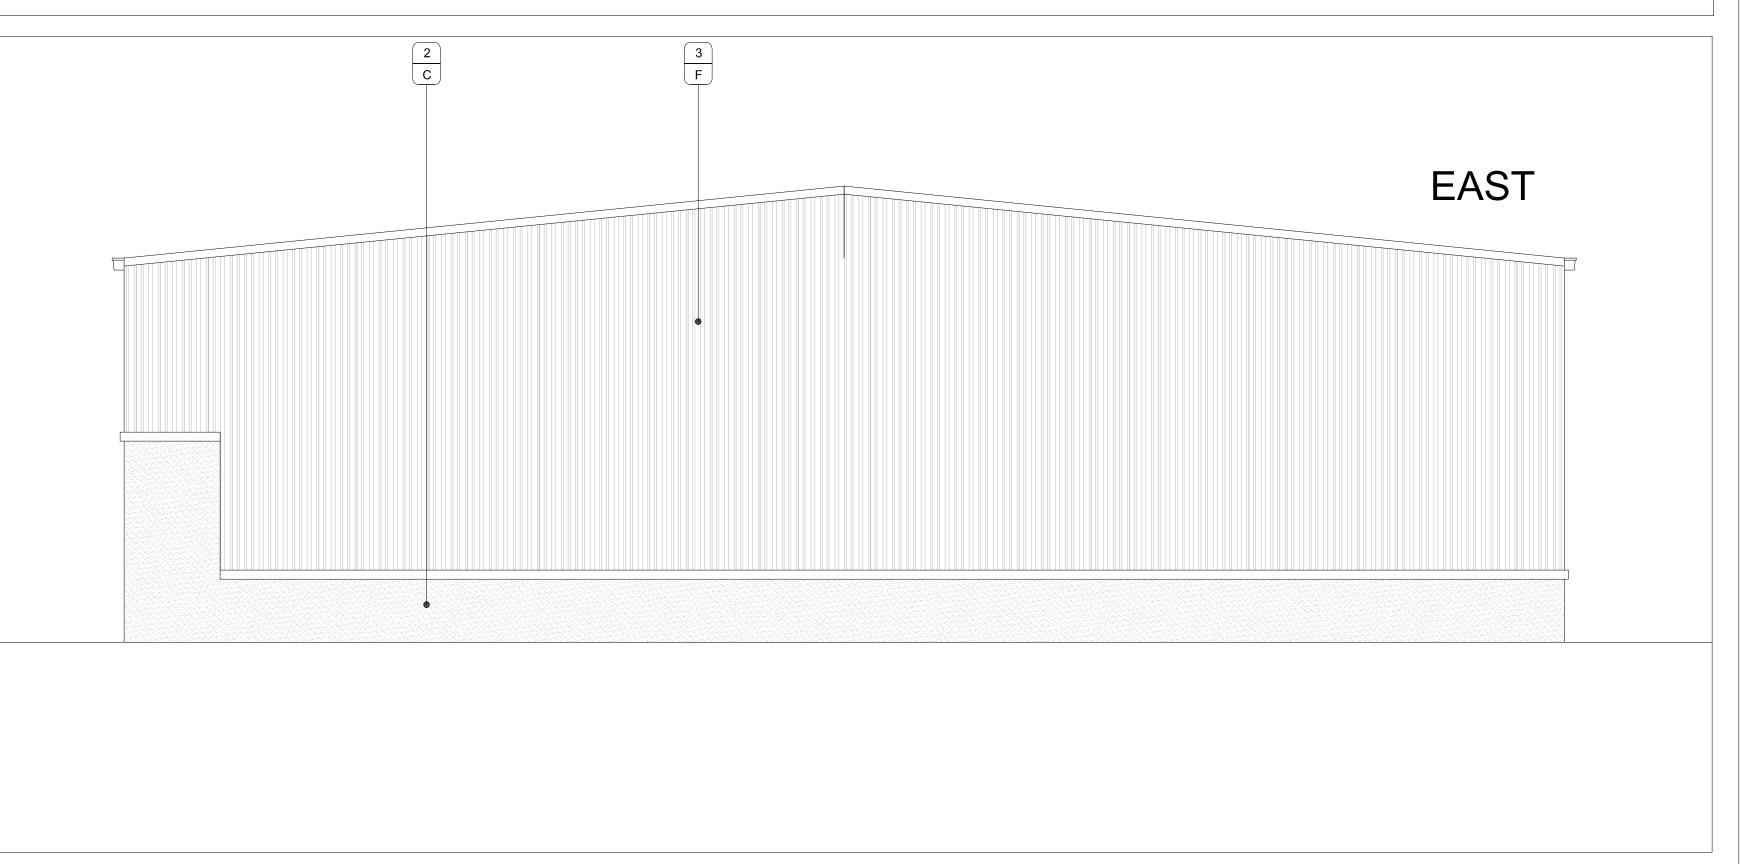

ELEVATIONS

1/4"=1'-0"

PIN: 01721000000008

CITY STAFF CERTIFICATE

APPROVED BY THE DEPARTMENT OF COMMUNITY DEVELOPMENT OF COMMERCE CITY, THIS _____DAY OF ____,2022.

DEPARTMENT OF COMMUNITY DEVELOPMENT

621 SOUTHPARK DR., SUITE 1600 LITTLETON CO, 80120 PHONE: (303) 979-3900 INFO@HABERERGROUP.COM

Know what's below, Call before you dig. CALL 811 2-BUSINESS DAYS IN ADVANCE BEFORE YOU DIG, GRADE, OR EXCAVATE FOR THE MARKING OF UNDERGROUND

MEMBER UTILITIES.


REVISIONS: No. Date: Description: 1 1.21.22 1ST SUB 2 4.14.23 2ND SUB Project No: HCI 20_01 Checked By: Date Issued:

Sheet Number:

2023-04-20 Sheet Name:

A PARCEL OF LAND SITUATED IN THE NORTHWEST 1/4 OF SECTION 28, TOWNSHIP 2 SOUTH, RANGE 67 WEST OF THE 6TH P.M., CITY OF COMMERCE CITY, COUNTY OF ADAMS, STATE OF COLORADO


		AREA	PERCENTAGE
WEST			
	STUCCO	412	40.00%
	STOREFRONT	114	11.07%
	METAL SIDING	504	48.93%
	TOTAL	1030	
EAST			
-	STUCCO	203	19.71%
	METAL SIDING	827	80.29%
	TOTAL	1030	
NORTH			
	STUCCO	131	7.04%
	DOORS	96	5.16%
	METAL SIDING	1633	87.80%
	TOTAL	1860	
SOUTH			
	STUCCO	294	15.81%
	STOREFRONT	162	8.71%
	DOORS	450	24.19%
	METAL SIDING	954	51.29%
	TOTAL	1860	

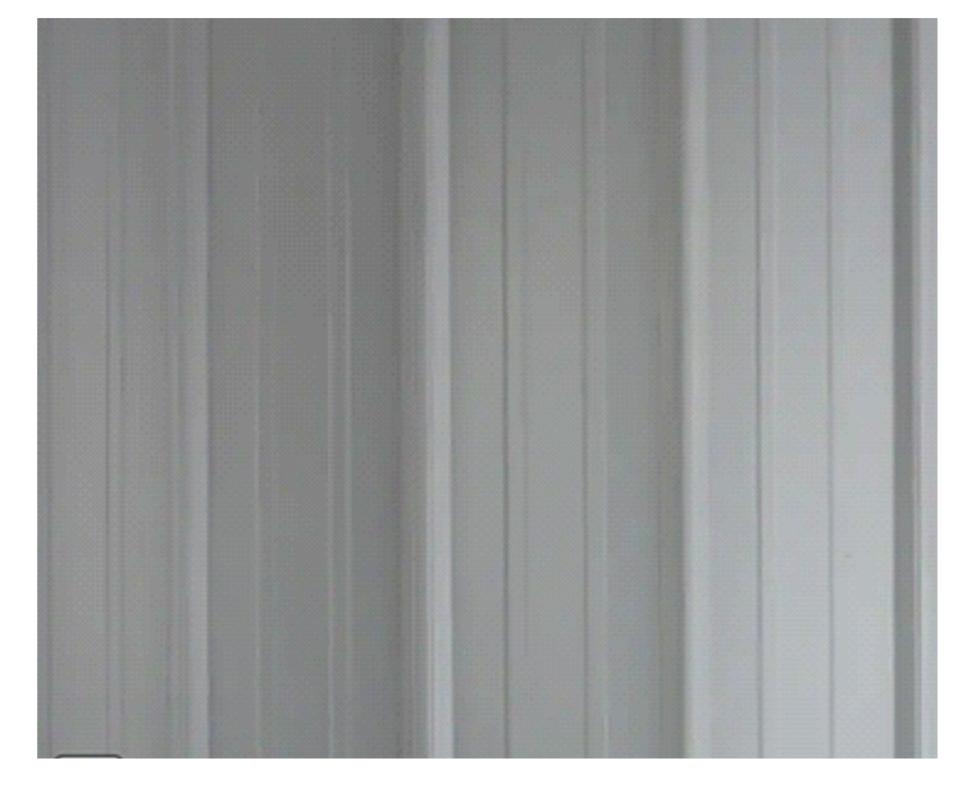




ING

STOREFRONT

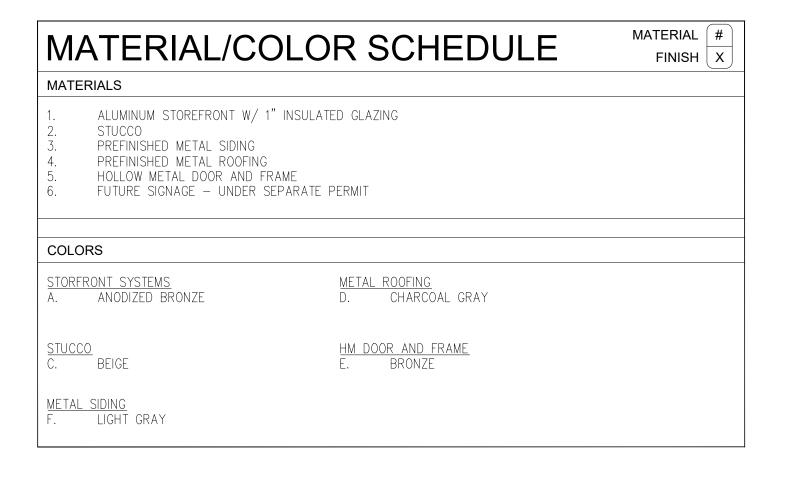

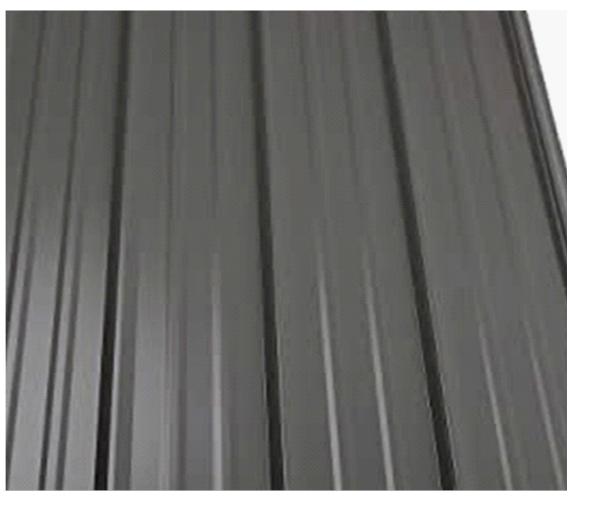

ROOF STUCCO

CITY STAFF CERTIFICATE

APPROVED BY THE DEPARTMENT OF COMMUNITY DEVELOPMENT OF COMMERCE CITY, THIS _____DAY OF_____,2022.

PIN: 01721000000008

A DIVISION OF
HABERER CARPENTRY INC.
621 SOUTHPARK DR., SUITE 1600
LITTLETON CO, 80120
PHONE: (303) 979-3900
INFO@HABERERGROUP.COM

Know what's below ,
Call before you dig.

CALL 811 2-BUSINESS DAYS IN ADVANCE BEFORE YOU DIG, GRADE, OR EXCAVATE FOR THE MARKING OF UNDERGROUND MEMBER UTILITIES.

ARY PLANS CITY, IS, DO


8550 ROSEMAR
EVELOPMENT PL
CITY OF COMMERCE CITY
COUNTY OF ADAMS,
STATE OF COLORADO

REV	ISIONS:	
No.	Date:	Description:
1	1.21.22	1ST SUB
2	4.14.23	2ND SUB
Proje	ect No:	HCI 20_01

Proje	ect No:	HCI 20_01
Drav	vn By:	ZKA
Che	cked By:	TGG
Date	Issued:	2023-04-20
Shee	et Name:	

Sheet Number:

A PARCEL OF LAND SITUATED IN THE NORTHWEST 1/4 OF SECTION 28, TOWNSHIP 2 SOUTH, RANGE 67 WEST OF THE 6TH P.M., CITY OF COMMERCE CITY, COUNTY OF ADAMS, STATE OF COLORADO

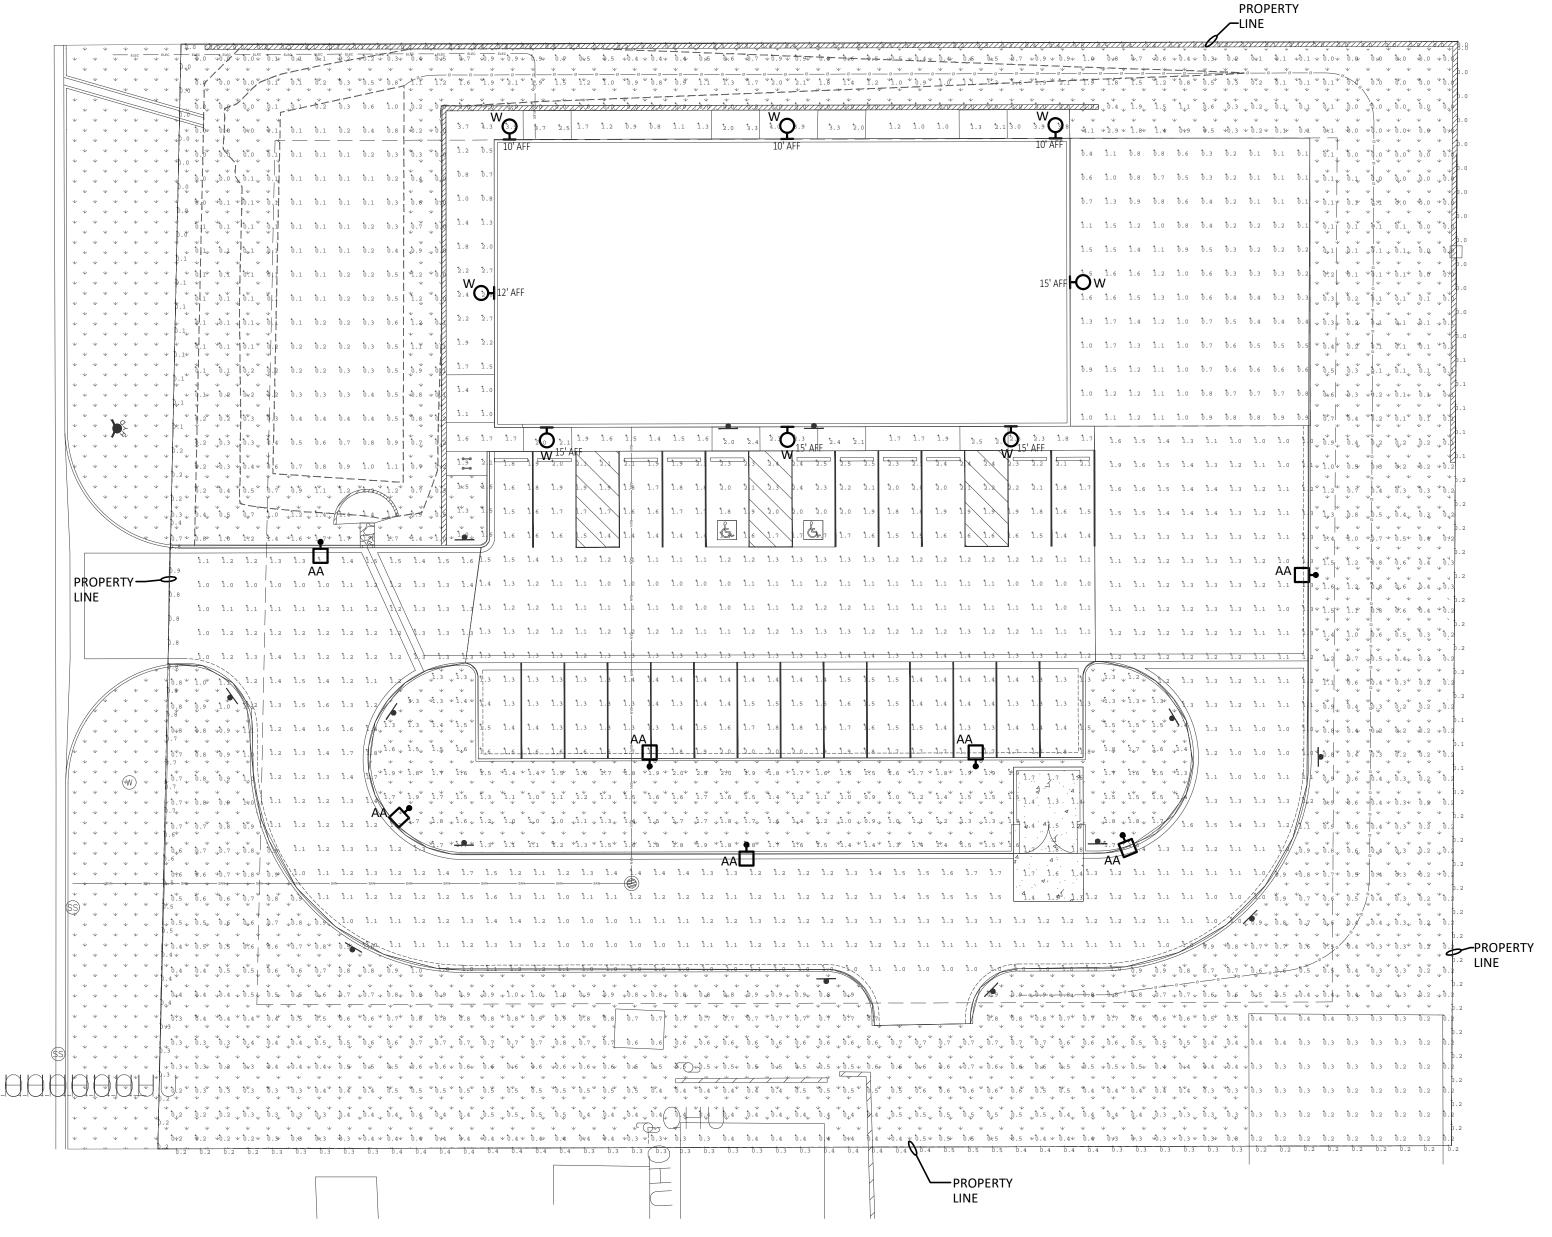

SITE 1 LIGHTING PLAN SCALE: 1"=20'-0"

				Light F	ixture Sch	nedule				
Designation		Lamps	Fixture Characteristics		Fixture Moun	ting			Fixture Specification	
						Ceiling	Recess			
	# of lamps	Lamp Type	Description	Finish	Method	Type	Depth	Manufacturer	Catalog #	Voltage
AA	1	LED - 9,591 Lumens, 66W (3000K)	LED Pole Mounted Fixture with Type IV Forward Throw Distribution	Black	Pole: Overall Height 27'-6" AFF		-1	McGraw-Edison	GLEON-SA1A-830-U-T4FT-BK	277
W			LED Wall Mounted Fixture with Type II	Black	Wall: As			McGraw-Edison	IST-SA1A-830-U-T2-BK	277
		20.1 Watts (3000K)	Distribution		Noted					

APPROVED BY THE DEPARTMENT OF COMMUNITY DEVELOPMENT OF COMMERCE CITY, THIS _____DAY OF ____,2022.

DEPARTMENT OF COMMUNITY DEVELOPMENT

CITY STAFF CERTIFICATE

PIN: 01721000000008

A DIVISION OF HABERER CARPENTRY INC. 621 SOUTHPARK DR., SUITE 1600 LITTLETON CO, 80120 PHONE: (303) 979-3900

INFO@HABERERGROUP.COM

Know what's below, Call before you dig. CALL 811 2-BUSINESS DAYS IN ADVANCE BEFORE YOU DIG,


GRADE, OR EXCAVATE FOR THI MARKING OF UNDERGROUND MEMBER UTILITIES.

REVISIONS: 1.21.22 | 1ST SUB 5.05.23 2ND SUB

Project No: 23-038 Drawn By: Checked By: Date Issued: 2023-05-05 Sheet Name:

SITE PHOTOMETRICS Sheet Number:

PH1.0

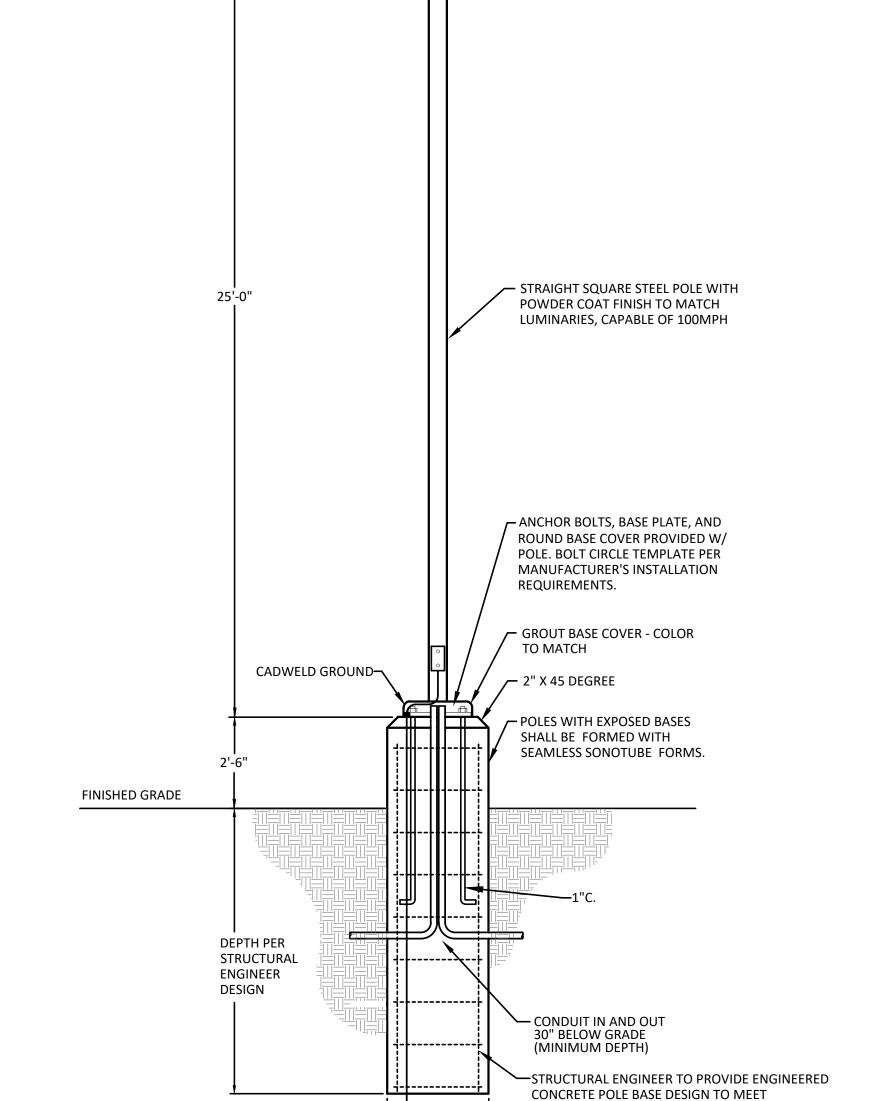

FULL CUT OFF LED FIXTURE.

SINGLE HEAD FOR TYPE 'A'.

TYPE 'AA' POLE BASE DETAIL - ELEVATED BASE NOT TO SCALE

10' X 3/4" GND. ROD-

Label	CalcType	Units	Avg	Max	Min	Avg/Min	Max/Min
Driveway	Illuminance	FC	1.21	1.9	1.0	1.21	1.90
Exterior Door #1	Illuminance	Fc	1.70	2.1	1.3	1.31	1.62
Exterior Door #2	Illuminance	Fc	2.65	3.3	2.0	1.33	1.65
Exterior Door #3	Illuminance	FC	2.65	3.3	2.0	1.33	1.65
Exterior Door #4	Illuminance	FC	3.10	3.7	2.5	1.24	1.48
Exterior Door #5	Illuminance	Fc	1.13	1.4	1.0	1.13	1.40
Exterior Door #6	Illuminance	FC	2.05	2.1	2.0	1.03	1.05
Exterior Door #7	Illuminance	Fc	2.20	2.4	2.0	1.10	1.20
Exterior Door #8	Illuminance	FC	2.25	2.4	2.1	1.07	1.14
Exterior Door #9	Illuminance	Fc	2.45	2.5	2.4	1.02	1.04
Future Building	Illuminance	Fc	0.77	1.7	0.1	7.70	17.00
Island Landscape	Illuminance	FC	1.49	2.0	0.9	1.66	2.22
Landscape	Illuminance	FC	0.48	4.1	0.0	N.A.	N.A.
Parking Lot	Illuminance	FC	1.49	2.5	1.0	1.49	2.50
Property Line	Illuminance	Fc	0.26	0.9	0.0	N.A.	N.A.
Sidewalk	Illuminance	Fc	1.89	4.3	0.5	3.78	8.60
Trash Enclosure	Illuminance	FC	1.54	1.8	1.3	1.18	1.38


SPECIFICATIONS AS SHOWN WITH RESPECT TO


POLE HEIGHT AND WIND RATING.

A PARCEL OF LAND SITUATED IN THE NORTHWEST 1/4 OF SECTION 28, TOWNSHIP 2 SOUTH, RANGE 67 WEST OF THE 6TH P.M., CITY OF COMMERCE CITY, COUNTY OF ADAMS, STATE OF COLORADO



Product Family 1, 2 Configuration Drive		ngine Drive Current	Color Temperature	Voltage	Distribution	Mounting	Finish AP=Grey BZ=Bronze BK=Black DP=Dark Platinum GM=Graphite Metallic WH=White RALXX=Custom Color
GLEON=Gaileon BAA-GLEON=Gaileon, Buy American Act Compilant ³⁵ TAA-GLEON=Gaileon, Trade Agreements Act Compliant ³⁶	EON-Galleon A-GLEON-Galleon, A-GLEON-Galleon, A-GLEON-Galleon, A-GLEON-Galleon, SA3-3 Squares SA4-4 Squares SA5-5 Squares A-GLEON-Galleon, SA5-5 Squares A-GLEON-Galleon B-GLEON-GALLEON B-GLE		722=70CRI, 2200K 727=70CRI, 2700K 730=70CRI, 3000K 735=70CRI, 3500K 740=70CRI, 4000K 750=70CRI, 5000K 750=70CRI, 6000K 827=80CRI, 2700K 830=80CRI, 3000K AMB=Amber, 590nm 14.16	U=120-277V 1=120V 2=208V 3=240V 4=277V 8=480V.** 9=347V.*	T2=Type II T2R=Type III Roadway T3=Type III Roadway T3=Type III Roadway T4FT=Type IV Forward Throw T4W=Type IV Wride SNQ=Type V Square Medium SNQ=Type V Square Medium SNQ=Type V Square Wride SL2=Type II w/Spill Control SL3=Type II w/Spill Control SL4=Type IV w/Spill Control SL4=Type IV w/Spill Control SL4=0° Spill Light Eliminator Left SLR=90° Spill Light Eliminator Right RW=Rectangular Wride Type I AFL=Automotive Frontline		
20K-Series 20KV UL 14 2L-Two Circuits 7-19 HA-50°C High Ambient HSS-Installed House Si GRSBK-Glare Reducing GRSWH-Glare Reducing LGF-Light Square Tim WT-Installed Mesh Top TH-Tool-less Door Harc CC-Coastal Construct 190-Optics Rotated 90° R90-Optics Rotated 90° R90-Optics Rotated 90° AHD145-After Hours Di AHD245-After Hours Di AHD255-After Hours Di DALI-DALI Drivers	de Shield ²⁸ Shield, Black ²³ Shield, White ²³ Painted to Match Hou Ware Left Right m, 5 Hours ²² m, 6 Hours ²² m, 7 Hours ²²	SPBA MS-L MS-L MS-L MS/X MS/D ZW-V ZD-S ZW-W 7'-11 ZW-W 15'-2 ZD-W Progr ZD-S 15'-2 ZD-S1'-11	=Dimming Occupancy Sens 20=Motion Sensor for ON/OF 40W-Motion Sensor for ON/OF 40W-Motion Sensor for ON/OF 4-140W-BI-Level Motion Sensor 1-40W-BI-Level Motion Sensor 10M-140W-Motion Sensor for D 10M-40W-Motion Sensor for OF 10MX-Wavel Linx Lite, Dimmi 10MX-Wavel Linx Lite, Dimmi 10° Mounting 13-23-3 10°FXX-Wavel Linx Lite, SR Driv ammable, 7' - 15' Mounting 13 0FXX-Wavel Linx Lite, SR Driv ammable, 7' - 15' Mounting 13 0FXX-Wavel Linx Lite, SR Driv ammable, 15' - 40' Mounting 10°FXX-Wavel Linx Lite, SR Driv ammable, 15' - 40' Mounting 10°FXX-Wavel Linx Lite, SR Driv ammable, 15' - 40' Mounting 10°FXX-Wavel Linx Lite, SR Driv WDP4XX-Wavel Linx Lite, SR Driv WDP4XX-Wavel Linx Lite, SR Driv Mounting 13-24' Mounting 10°FX-Wavel Linx Lite, SR Driv 10°FX-Wavel Linx Lite, SR Driv 1	or with Blueto, or F Operation, or F Operation of Poperation of Poperati	11 - 40' Mounting Height 24' g Height 24' s Jelight 24' s Intig Height 24' sting Height 24' sing Height 24' sing, 21' - 40' Mounting Height 24' saylight, Bluetooth Programmable, aylight, Bluetooth Programmable, tion and Daylight, Bluetooth ion and Daylight, Bluetooth In Daylight, WAC Programmable, Intigrammable, WAC Programmable, Intigrammable, WAC Programmable, Intigrammable, WAC Programmable, Intigrammable, WAC Programmable, WAC Programma	OA/RA1013-Photocontrol Shorting Cap OA/RA1014-PloyPhotocontrol MA1252-10kV Surge Module Replacement MA1252-10kV Surge Module Replacement MA1253-W-Single Tenon Adapter for 2-3/8" O.D. MA1037-XX-2@180" Tenon Adapter for 2-3/8" O.D. MA1037-XX-2@180" Tenon Adapter for 2-3/8" O.D. MA1197-XX-2@102" Tenon Adapter for 2-3/8" O.D. MA1189-XX-2@90" Tenon Adapter for 2-3/8" O.D. MA1199-XX-2@90" Tenon Adapter for 2-3/8" O.D. MA1191-XX-2@102" Tenon Adapter for 2-3/8" O.D. MA1191-XX-2@102" Tenon Adapter for 3-1/2" O.D. MA1039-XX-2@180" Tenon Adapter for 3-1/2" O.D. MA1039-XX-2@180" Tenon Adapter for 3-1/2" O.D. MA1193-XX-2@102" Tenon Adapter for 3-1/2" O.D. MA1193-XX-3@102" Tenon Adapter for 3-1/2" O.D. MA1193-XX-3@102" Tenon Adapter for 6-1/2" O.D. MA103-XX-3@102" Tenon Adapter fo	D. Tenon D. Tenon Tenon Tenon Tenon Tenon Tenon D. Tenon Tenon D. Tenon D. Tenon D. Tenon
1. Customer is responsible from the transport of the cour white paper WP51300 2. DesignLights Consortium for details. 3. Coastal construction finis ASTM D1654. Not available 4. Not compatible with M245. Not compatible with experiment and the compatible with experiment able. 10. Factory installed. 11. Maximum 8 light square 11. Maximum 8 light square 11. Maximum 8 light square 12. Requires 27 of 27 levery 14. Narrow-band 590nm +/. 13. Requires 27 of 27 levery 14. Narrow-band 590nm +/.	It EN for additional suppo Qualified. Refer to www. h salt spray tested to over with TH option. -LVX or MS/T-LXX sensor ded quick mount arm (QM sale quick mount arm (QM small step down transform bale in combination with it term only. Per NEC, not for Commonly known as Thr d Delta systems.) or more luminaires are or commonly known as Thr d Delta systems.) is, is, is, is, is, is, is, is,	ri information. seisginglights org Qualit 5,000-hours per ASTN s. IEA). Jo er extended quick mer when combined wir the HA high ambient a use with ungrounded ee Phase Three William and valory use. Choose dr. L4 distributions. Can IA Vor of 480V. 2L in SA Vor of 480V. 2L in SA	th sensor options. Not available win do sensor options at 1A. systems, impedance grounded systetta, Three Phase High Leg Delta a p* drilling pattern. Refer to arm moi	19. Cam. 19. Cam. 21. Not 22. Regular 6	radditional information, or use with TaFL, TaW or SL4 optics. See IES fir SIR-100 configuration tool is required to adjust ingerpresentative at Cooper Lighting Solution ace X with number of Light Squares operating in the Company of	s ensor has an integral photocell. PR photocontrol receptacle with photocontrol accessory. See <i>I</i> les for details. It parameters including high and low modes, sensitivity, time del is for more information. In low output mode. Trequiring network components LWP-EM-1, LWP-GW-1 and LWP ack trim plate is used when HSS is selected. M, BPC, PR or PR7 options. Available in 120-277V only. See the Component of t	ay, cutoff and more. Consult PoE8 in appropriate upply if needed. 1933 (BAA) or Trade Agree- upponents shipped separatel
 Not available with HA op 2L is not available with M normally used for SA5 or SA 			era Technology Onti	ons (Add as	Suffix)		
16. Not available with HA op 17. 2L is not available with h normally used for SA5 or SA 90° or 120°. Refer to arm mo	ated Network S	Security Cam	Camera Typ	•		Data Backhaul	

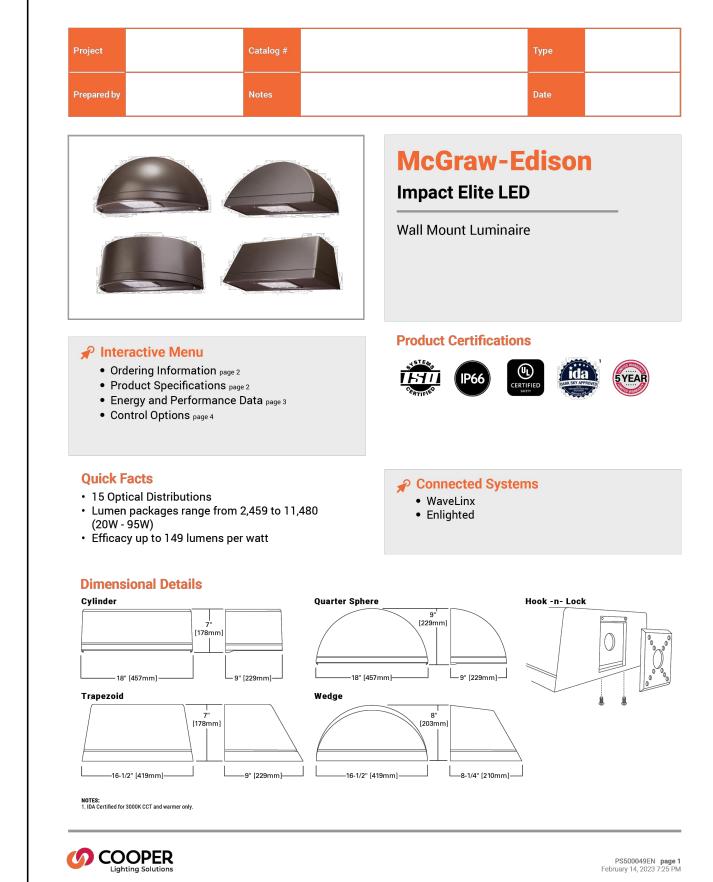

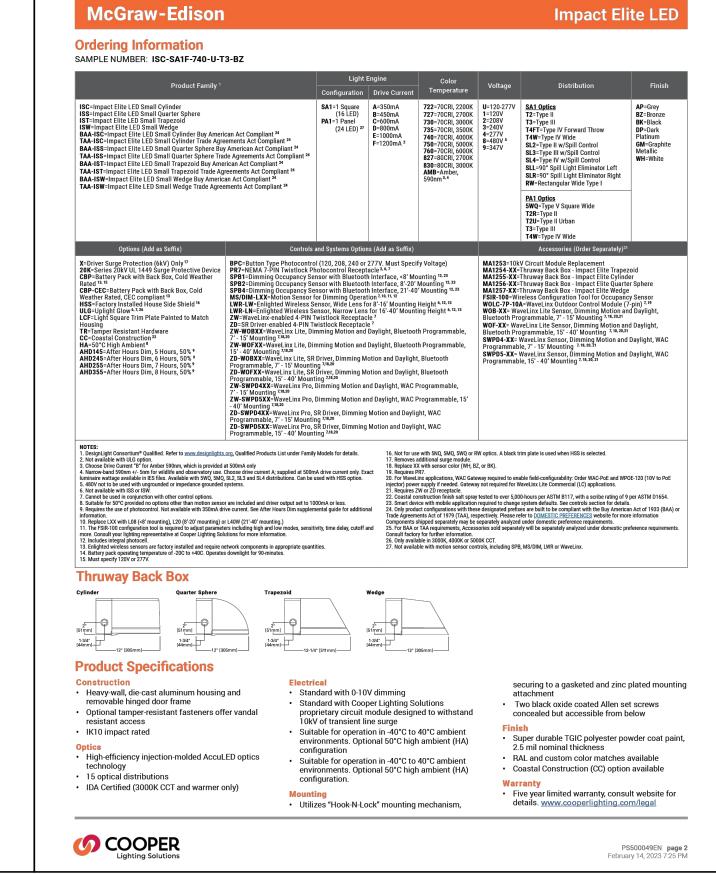





PIN: 01721000000008



APPROVED BY THE DEPARTMENT OF COMMUNITY DEVELOPMENT OF COMMERCE CITY, THIS _____DAY OF____,2022.

DEPARTMENT OF COMMUNITY DEVELOPMENT

A DIVISION OF

HABERER CARPENTRY INC.
621 SOUTHPARK DR., SUITE 1600
LITTLETON CO, 80120
PHONE: (303) 979-3900

INFO@HABERERGROUP.COM

CALL 811 2-BUSINESS DAYS IN ADVANCE BEFORE YOU DIG, GRADE, OR EXCAVATE FOR THE MARKING OF UNDERGROUND

MEMBER UTILITIES.

8550 ROSEMARY

VELOPMENT PLAN

CITY OF COMMERCE CITY,

COUNTY OF ADAMS,

STATE OF COLORADO

Project No: 23-038

Drawn By: JJW

Checked By: VJR

Date Issued: 2023-05-05

Sheet Name:

FIXTURE CUT SHEETS
Sheet
Number:

PH2.0