BASIS OF BEARING

THE GPS DERIVED NORTH LINE OF SECTION 21, TOWNSHIP 2 SOUTH, RANGE 67 WEST, OF THE 6TH PRINCIPAL MERIDIAN AS EVIDENCED BY THE NORTH QUARTER CORNER OF SAID SECTION (BEING A FOUND 3 1/4" ALUMINUM CAP) FROM WHENCE THE NORTHEAST QUARTER CORNER OF SAID SECTION (BEING A FOUND 3 1/4" BRASS CAP) BEARS NORTH 89°40'40" EAST A DISTANCE OF 2641.08 FEET, WITH ALL BEARINGS HEREIN RELATIVE THERETO.

BENCHMARK

FOUND ALUMINUM CAP STAMPED "17468" LOCATED AT THE INTERSECTION OF E 96TH AVE AND YOSEMITE ST. NAVD 88 ELEVATION = 5097.98

LEGAL DESCRIPTION

KNOW ALL MEN BY THESE PRESENTS THAT MACKEY HOLDINGS LLC, BEING THE OWNER OF THAT PART OF THE NORTHEAST 1/4 OF SECTION 21, TOWNSHIP 2 SOUTH, RANGE 67 WEST OF THE 6TH PRINCIPAL MERIDIAN, COMMERCE CITY, COUNTY OF ADAMS, STATE OF COLORADO, BEING MORE PARTICULARLY DESCRIBED AS FOLLOWS:

LOT 1, MARTY FARMS SUBDIVISION FILING NO. 6, COMMERCE CITY, COUNTY OF ADAMS, STATE OF COLORADO

CONTAINING: 122.403 SQ. FT., OR 2.811 ACRES, MORE OF LESS.

NOTE

- 1. SITE WORK FOR THIS PROJECT SHALL MEET OR EXCEED THE PROJECT SPECIFICATIONS AND CITY OF COMMERCE CITY STANDARDS WHICH ARE HEREBY REFERENCED AS PART OF THESE PLANS.
- 2. THE DESIGN SHOWN IS BASED UPON THE ENGINEER'S UNDERSTANDING OF THE EXISTING CONDITIONS. THIS PLAN DOES NOT REPRESENT A DETAILED FIELD SURVEY. THE EXISTING CONDITIONS SHOWN ON THIS PLAN SHEET ARE BASED UPON SURVEY PREPARED BY FALCON SURVEYING, INC., DATED 5/07/2020. THE CONTRACTOR IS RESPONSIBLE FOR VERIFYING FIELD CONDITIONS PRIOR TO BIDDING THE PROPOSED SITEWORK IMPROVEMENTS. IF CONFLICTS ARE DISCOVERED, THE CONTRACTOR SHALL NOTIFY THE OWNER PRIOR TO INSTALLATION OF ANY PORTION OF THE SITEWORK WHICH WOULD BE AFFECTED. IF CONTRACTOR DOES NOT ACCEPT EXISTING SURVEY, INCLUDING TOPOGRAPHY AS SHOWN ON THE PLANS, WITHOUT EXCEPTION, HE SHALL HAVE MADE, AT HIS OWN EXPENSE, A TOPOGRAPHIC SURVEY BY A REGISTERED LAND SURVEYOR AND SUBMIT IT TO THE OWNER FOR REVIEW.
- 3. <u>CAUTION NOTICE TO CONTRACTOR</u>
 - THE CONTRACTOR IS SPECIFICALLY CAUTIONED THAT THE LOCATION OF EXISTING UTILITIES AS SHOWN ON THESE PLANS IS BASED ON RECORDS OF THE VARIOUS UTILITY COMPANIES AND, WHERE POSSIBLE. MEASUREMENTS TAKEN IN THE FIELD. THE INFORMATION IS NOT TO BE RELIED ON AS BEING EXACT OR COMPLETE. THE CONTRACTOR MUST CALL THE APPROPRIATE UTILITY COMPANY AT LEAST 48 HOURS BEFORE ANY EXCAVATION TO REQUEST EXACT FIELD LOCATION OF UTILITIES. IT SHALL BE THE RESPONSIBILITY OF THE CONTRACTOR TO RELOCATE ALL EXISTING UTILITIES WHICH CONFLICT WITH THE PROPOSED IMPROVEMENTS SHOWN ON THESE PLANS.

COMMERCE CITY NOTES

PROJECT IS PART OF THE "MARTY FARMS INDUSTRIAL CENTER - AMENDMENT NO. 2 PUD".

IN THE INTEREST OF COMPATIBILITY OF SURROUNDING LAND USES. ILLUMINATION OF ANY KIND ON PRIVATE PROPERTY SHALL BE DIRECTED AND CONTROLLED IN SUCH A MANNER SO THAT THERE SHALL BE NO DIRECT RAYS OF LIGHT WHICH EXTEND BEYOND THE BOUNDARIES OF THE PROPERTY FROM WHICH IT ORIGINATES.

TRASH ENCLOSURE NOTE:

TRASH ENCLOSURES SHALL BE CONSTRUCTED TO A MINIMUM HEIGHT OF SIX (6) FEET AND OF THE SAME OR COMPLEMENTARY MATERIAL AND COLOR AS THE MAIN BUILDING.

ROOF MOUNTED ELECTRICAL AND MECHANICAL EQUIPMENT SHALL BE PLACED OR SCREENED SUCH THAT THE EQUIPMENT IS NOT VISIBLE FROM ANY POINT. SUCH EQUIPMENT SHALL BE SCREENED WITH THE SAME MATERIALS AND COLORS AS THE MAIN BUILDING.

SIGNAGE NOTE:

APPROVAL OF A SIGN PERMIT IS REQUIRED IN ADDITION TO THE DEVELOPMENT PLAN APPROVAL. SIGN LOCATIONS SHOWN ON THE DEVELOPMENT PLAN WILL BE REVIEWED FOR POSSIBLE CONFLICTS WITH SIGHT TRIANGLES AND EASEMENTS, HOWEVER, THESE SIGNS WILL NOT BE APPROVED BY THE DEVELOPMENT PLAN REVIEW PROCESS OR APPROVAL OF THIS DEVELOPMENT PLAN. ALL SIGNS MUST CONFORM TO THE CITY OF COMMERCE CITY'S SIGN CODE.

APPROVAL OF A FENCE PERMIT IS REQUIRED IN ADDITION TO DEVELOPMENT PLAN APPROVAL. ALL FENCES MUST CONFORM TO THE CITY OF COMMERCE CITY'S FENCING REQUIREMENTS.

NO DOWNSPOUT OUTFALLS WILL BE ALLOWED TO DRAIN OVER SIDEWALKS, BIKE PATHS, OR ANY OTHER PEDESTRIAN ROUTE.

AMERICANS WITH DISABILITIES NOTE: THE APPLICANT HAS THE OBLIGATION TO COMPLY WITH ALL APPLICABLE REQUIREMENTS OF THE

COMPLIANCE WITH THIS ACT.

CONSTRUCTION NOTE: THE APPROVAL OF THIS DEVELOPMENT PLAN DOES NOT CONSTITUTE FINAL APPROVAL OF GRADING, DRAINAGE, UTILITY, PUBLIC IMPROVEMENTS AND BUILDING PLANS. THESE PLANS MUST BE REVIEWED


AMERICAN DISABILITIES ACT. APPROVAL OF THIS DEVELOPMENT PLAN DOES NOT CONSTITUTE

AND APPROVED BY THE APPROPRIATE AGENCY PRIOR TO ISSUANCE OF BUILDING PERMITS.

ALL OVERHEAD UTILITIES SERVING THIS SITE MUST BE PLACED UNDERGROUND PER LAND DEVELOPMENT

ALL EXISTING BUILDINGS AND APPURTENANCES WILL BE DEMOLISHED AS PART OF THIS PROJECT.

LOT 1 MARTY FARMS SUBDIVISION FILING NO. 6 LOCATED IN SECTION 21, TOWNSHIP 2 SOUTH, RANGE 67 WEST OF THE 6TH P.M. CITY OF COMMERCE CITY, COUNTY OF ADAMS, STATE OF COLORADO

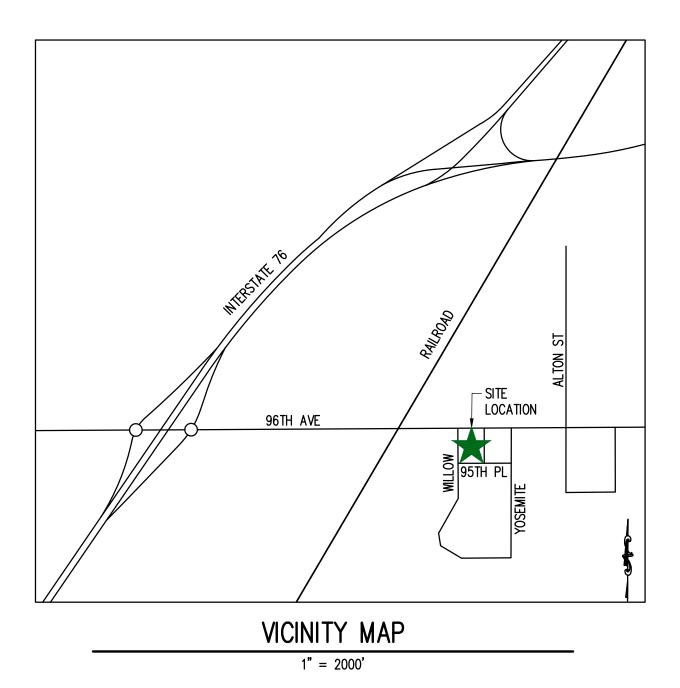

	DRAWING INDEX	
SHEET	DRAWING TITLE	#
CV-1	COVER SHEET	1
C-1.0	SITE PLAN	2
C-2.0	GRADING AND DRAINAGE PLAN	3
C-3.0	UTILITY PLAN	4
C-4.0	DETAILS	5
L-1.0	LANDSCAPE PLAN	6
L-1.1	LANDSCAPE DETAILS	7
PH-1	LIGHTING PLAN	8
A-4.1	EXTERIOR ELEVATIONS	9

PROJECT CONTACTS:

OWNER/APPLICANT

DENVER, CO 80231

(303) 909-2508

2200 S. VALENTIA ST.

CONTACT: KAREN KENNEDY

FALCON SURVEYING, INC.

CONTACT: JEFF MACKENNA

ARCHITECT STUDIO DH ARCHITECTURE

1300 JACKSON ST, SUITE 200

9940 W. 25TH AVE

(303) 202-1560

GOLDEN, CO 80401

CONTACT: JUSTIN FRIES

(720) 214-0342

CITY STAFF CERTIFICATE:

DEPARTMENT OF COMMUNITY DEVELOPMENT SIGNATURE

LAKEWOOD, CO 80215

HOMELAND

<u>CIVIL ENGINEER</u> RIDGETOP ENGINEERING AND SURVEYING 541 E. GARDEN DRIVE, UNIT N WINDSOR, CO 80550 (970) 663-4552 CONTACT: MIKE BEACH, P.E.

LANDSCAPE ARCHITECT JUMP DESIGN COMPANY 1733 SOUTH CLARKSON ST. DENVER, CO 80210 (303) 282-0463 CONTACT: TOM JUMP

KUMAR & ASSOCIATES, INC 2390 SOUTH LIPAN STREET DENVER, CO 80223 (303) 742-9700 CONTACT: CHAD BRINGLE

PHOTOMETRICS COLUMBINE ENGINEERING 7175 W. JEFFERSON AVE. SUITE 1000 LAKEWOOD, CO 80235 (720) 536-5150 CONTACT: JOHN LANG

COMMERCE CITY, CO PREPARED FOR **HOMELAND**

541 E. Garden Drive,

Windsor, CO 80550

PROJECT TITLE

LOT 1

MARTY FARMS:

9584 WILLOW COURT

W ridgetopeng.com

2200 S VALENTIA ST DENVER, CO 80231

SUBMITTAL **DEVELOPMENT PLAN**

> DRAWN BY: CHECKED BY: 20-143-001 PROJECT NO .: REVISIONS COMMENTS 1/5/22 COMMENTS 5/17/22 COMMENTS 9/15/22

7/23/2021

SHEET TITLE


COVER SHEET

SHEET INFORMATION

APPROVED BY THE DEPARTMENT OF COMMUNITY DEVELOPMENT OF THE CITY OF COMMERCE CITY, THIS _____ DAY OF _____ A.D. _____

Of

LOT 1 MARTY FARMS SUBDIVISION FILING NO. 6 LOCATED IN SECTION 21, TOWNSHIP 2 SOUTH, RANGE 67 WEST OF THE 6TH P.M. CITY OF COMMERCE CITY, COUNTY OF ADAMS, STATE OF COLORADO

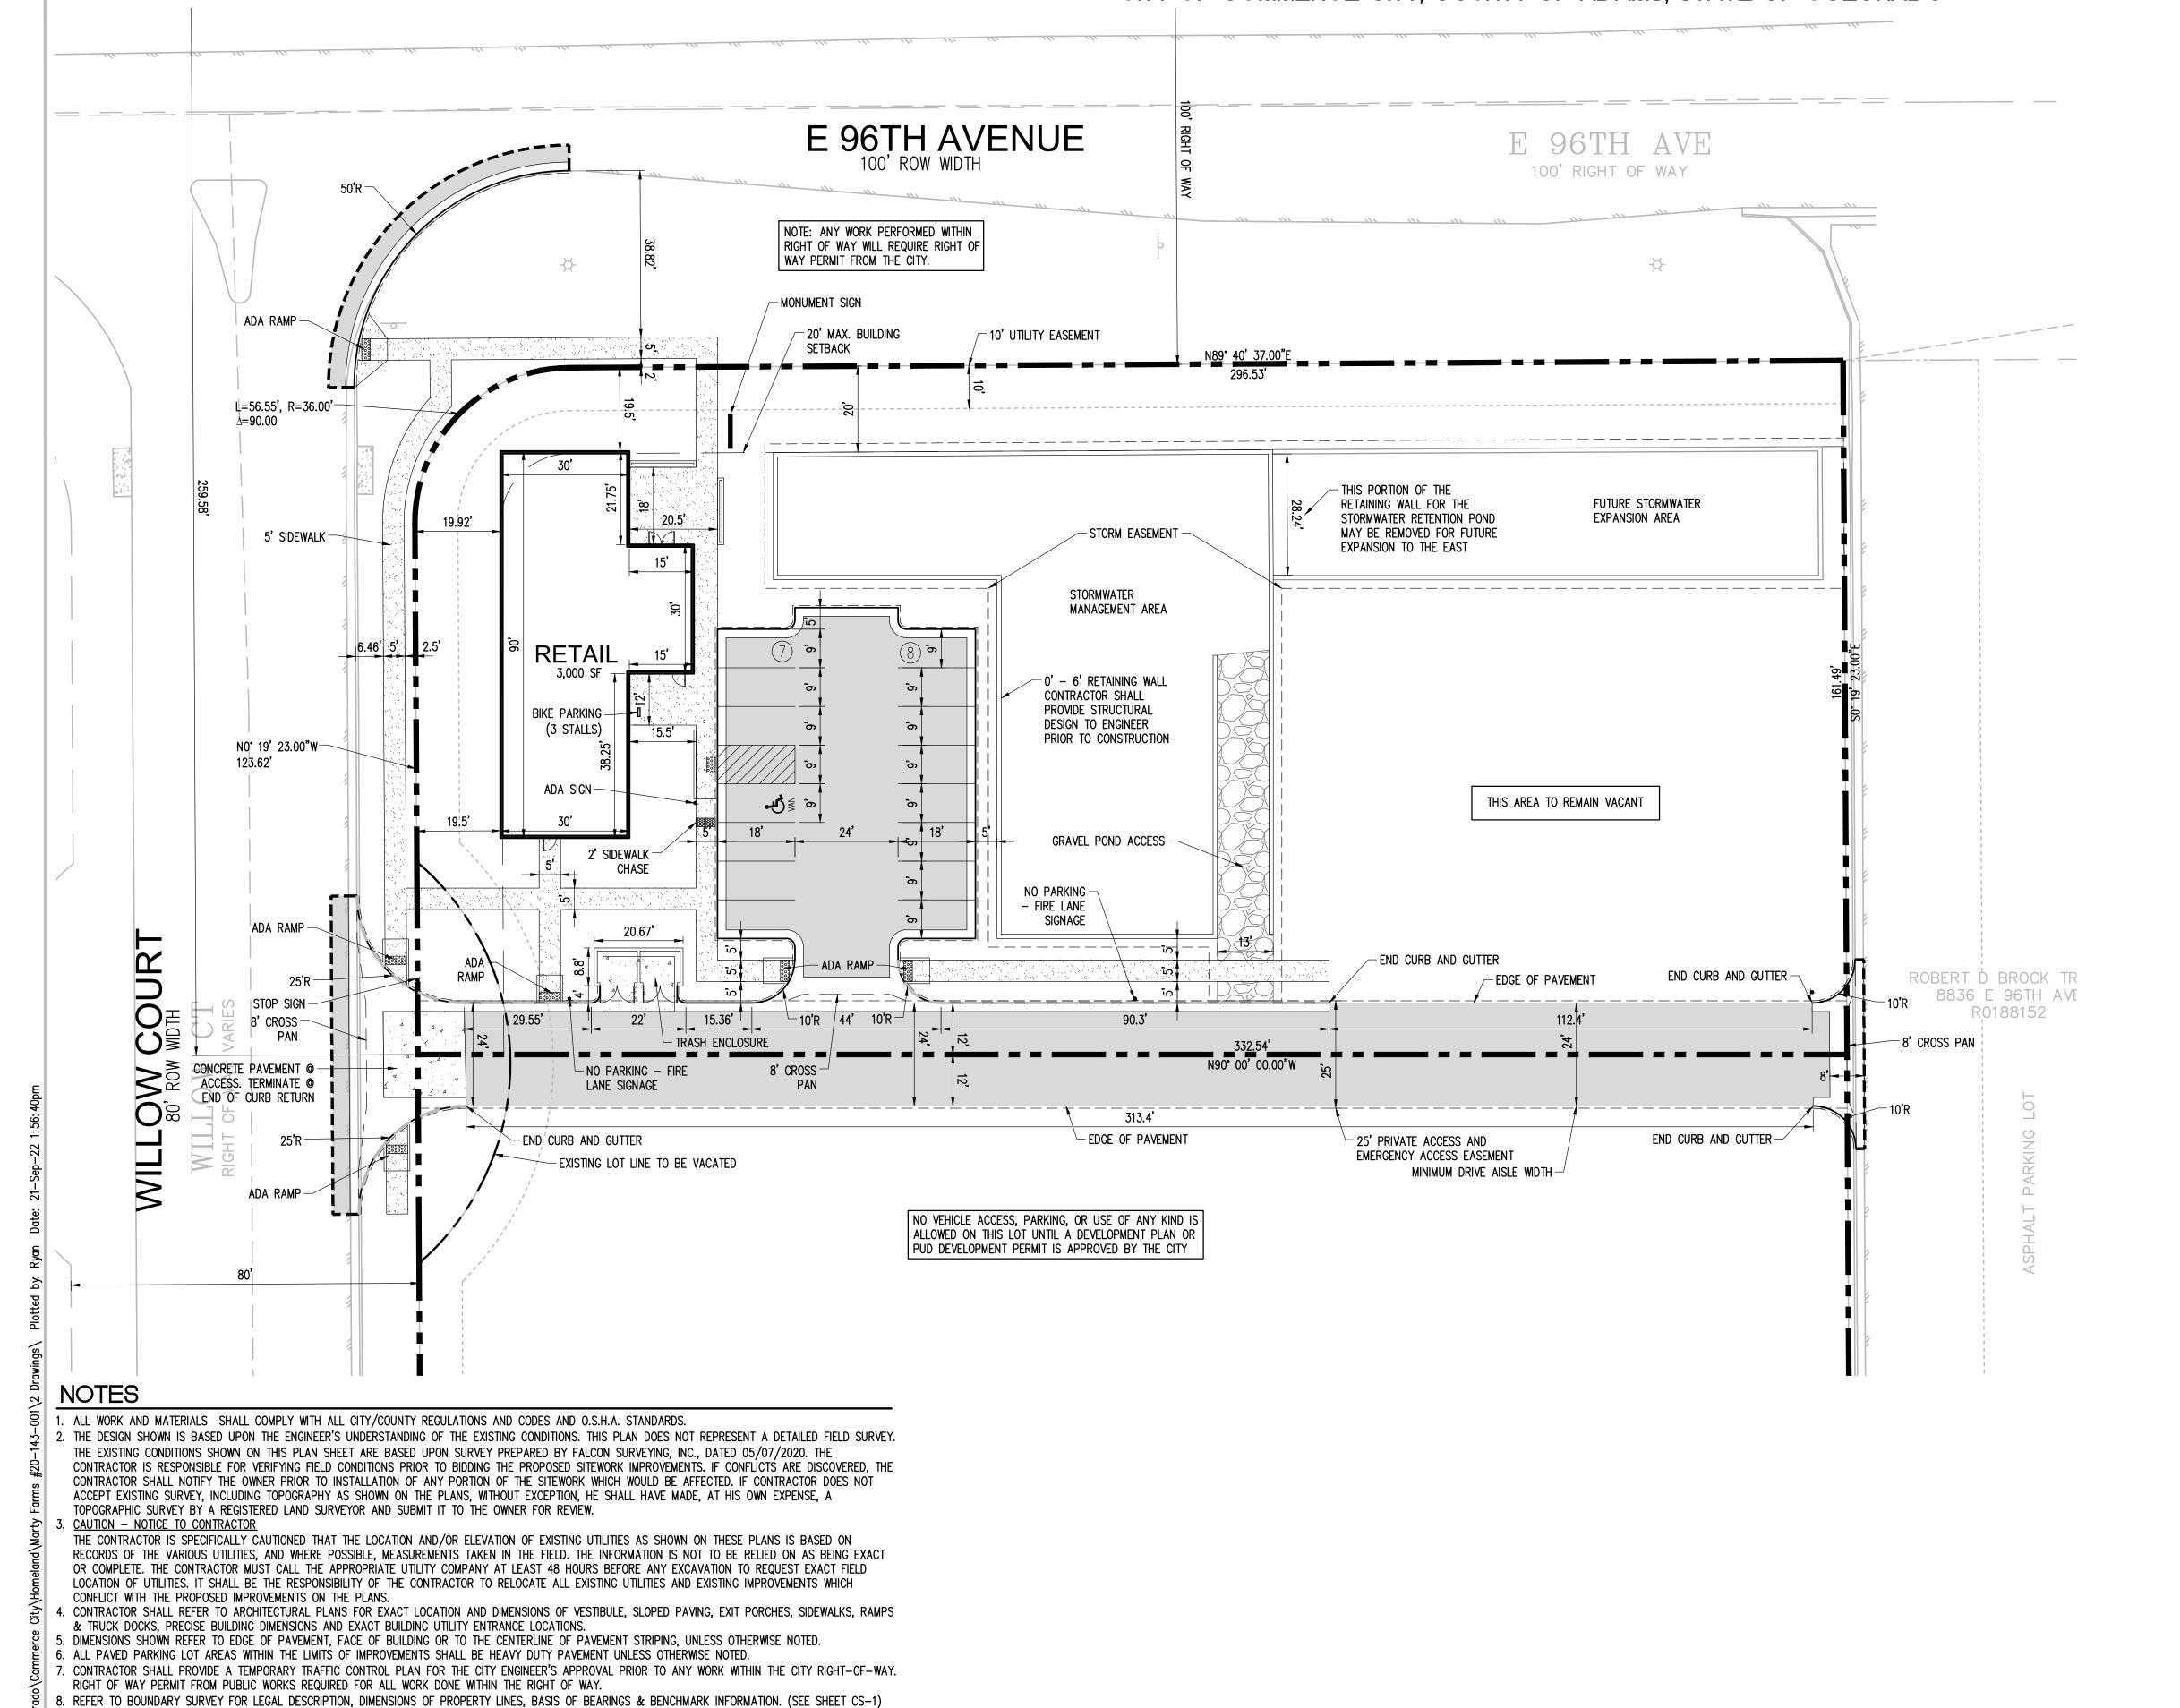

LEGEND

STANDARD DUTY ASPHALT

CONCRETE PAVEMENT

CONCRETE SIDEWALK

PROPERTY LINE

SETBACK LINE

CURB AND GUTTER

CURB AND GUTTER

CURB AND GUTTER — PAINTED FIRE LANE

SAWCUT

EDGE OF PAVEMENT

SITE DATA

LOT 1 (MARTY FARMS FILING #6) NET = 53,112 SF (1.219 AC)
LOT 1 (MARTY FARMS FILING #6) GROSS = 53,112 SF (1.219 AC)
SITE ADDRESS: 9584 WILLOW COURT, COMMERCE CITY, CO
PARCEL IDENTIFICATION NUMBER: 0172121103002
ANTICIPATED # OF EMPLOYEES: 2 to 3 PER SHIFT
TYPE OF CONSTRUCTION: WOOD FRAMED
ZONING (PROPOSED & EXISTING): PUD
MAXIMUM BUILDING HEIGHT: 50'
MAX. BUILDING SETBACK: 20'
LANDSCAPE AREA: 17,193 SF (32.4%)
VACANT LAND: 19,350 SF (36.4%)
FAR: 3,000/53,112 = 5.6%

BUILDING DATA

FLOOR AREA (FAR %)

RETAIL: = 3,000 SF (5.6%)

PARKING DATA

BIKE PARKING

PARKING PROVIDED

STANDARD STALLS = 14 STALLS

ACCESSIBLE STALLS = 1 STALLS

TOTAL STALLS = 15 STALLS

PARKING REQUIRED:

MIN: 1 STALL / 300 SF = 10

MAX: 150% OF MIN = 15

= 3 SPACES

RIDGEOP
ENGINEERING & SURVEYING
541 E. Garden Drive,
Unit N
Windsor, CO 80550

PROJECT TITLE

MARTY FARMS; LOT 1

9584 WILLOW COURT COMMERCE CITY, CO

HOMELAND

2200 S VALENTIA ST DENVER, CO 80231

SUBMITTAL

DEVELOPMENT PLAN

DRAWN BY:

PROJECT NO.: 20-143-001

REVISIONS

COMMENTS 1/5/22

COMMENTS 5/17/22

COMMENTS 9/15/22

7/23/2021

SHEET TITLE

SITE PLAN

N: 172121103002 SHEET INFORMATION

CITY STAFF CERTIFICATE:

APPROVED BY THE DEPARTMENT OF COMMUNITY DEVELOPMENT OF THE CITY OF

COMMERCE CITY, THIS _____ DAY OF _____ A.D. _____

DEPARTMENT OF COMMUNITY DEVELOPMENT SIGNATURE

1 inch = 20 ft.

10. PARKING LOT STRIPING SHALL BE YELLOW, 4" WIDTH, UNLESS OTHERWISE NOTED. LIGHT POLE BASES TO BE PAINTED TRAFFIC YELLOW (DOUBLE COAT)

11. ALL DISTURBED AREAS ARE TO RECEIVE FOUR INCHES OF TOPSOIL, SEED, MULCH AND WATER UNTIL A HEALTHY STAND OF GRASS IS ESTABLISHED.

12. ALL ISLANDS WITH CURB AND GUTTER SHALL BE LANDSCAPED. THOSE ISLANDS ARE TO HAVE 18" CURB AND GUTTER. ALL REMAINING ISLANDS ARE TO BE STRIPED AS SHOWN

로 STRIPED AS SHOWN.


13. EXISTING STRUCTURES WITHIN CONSTRUCTION LIMITS ARE TO BE ABANDONED, REMOVED OR RELOCATED AS NECESSARY. ALL COST SHALL BE INCLUDED IN BASE


14. CONTRACTOR SHALL BE RESPONSIBLE FOR ALL RELOCATIONS, INCLUDING BUT NOT LIMITED TO, ALL UTILITIES, STORM DRAINAGE, SIGNS, TRAFFIC SIGNALS & POLES, ETC. AS REQUIRED. ALL WORK SHALL BE IN ACCORDANCE WITH GOVERNING AUTHORITIES SPECIFICATIONS AND SHALL BE APPROVED BY SUCH. ALL COST SHALL BE INCLUDED IN BASE BID.

15. CURB RADII ADJACENT TO PARKING STALLS SHALL BE 2'. ALL OTHER CURB RADII SHALL BE 10', UNLESS OTHERWISE NOTED.

9. ALL ON-SITE PAINTED STRIPING SHALL BE SINGLE COATED.

LOT 1 MARTY FARMS SUBDIVISION FILING NO. 6 LOCATED IN SECTION 21, TOWNSHIP 2 SOUTH, RANGE 67 WEST OF THE 6TH P.M. CITY OF COMMERCE CITY, COUNTY OF ADAMS, STATE OF COLORADO **LEGEND** LEGEND - EXISTING POINT OF COMMENCEMENT NE 1/4 CORNER S21-T2W-R67W FOUND 3.25" ALUMINUM CAP BASIS OF BEARINGS S89°40'37"W 2641.08' 0.5' BELOW GRADE "LS 17468" EX. CONTOUR PROPOSED CONTOUR NORTH LINE NORTHEAST 1/4 SEC21-T2S-R67W EX. GAS LINE PROPERTY LINE E 96TH AVENUE SETBACK LINE SAN_MH_RIM: 50974s27 cas EX. UNDERGROUND ELECT PROPOSED STORM DRAI EX. UNDERGROUND COM TYPE 13 INLET \$088.80 EX. WATER SPOT ELEVATION 5088.85 SPILL CURB 5089.00 **RETENTION POND 1** EX. LIGHT POLE RIDGE/HIGHPOINT TC 5096.90 FL 5096.40 PROJECT TITLE SWALE/LOWPOIN1 **MARTY FARMS**; DAYLIGHT FL 5096.42 CUT LINE LOT 1 FL 5096.44 SW 96.77 TW 96.49₇ rFG 98.49 FG 98.49 LP 96.50-/ LP 96.50 FINISHED GRADE BW 91.75~ BW 91.75 9584 WILLOW COURT STORM EASEMENT SIDEWALK 30' WIDE COMMERCE CITY, CO POND 2 **EMERGENCY** EDGE OF PAVEMENT FUTURE STORMWATER OVERFLOW EXPANSION AREA HIGH POINT **HOMELAND** SW 99.00-/ SW 99.00-/ 18" RCP(W): 509(195) 4.2% TW 96.49 GR 91.75~ REQ. 100 YR VOL (P1 + P2): 1.057 AC-F1 GR 91.75_¬ FL 5097.62 PRO. VOL (P1 +P2): 1.171 AC-FT TC 5097.58 1.75' TALL BERM-TC 5098.21 TC 5098.18 RETAIL 100 YR WTR LVL: 5096.5 FL 5097.08 SW 99.00-\ L 5098.18 FOR WATER RIPRAP PAD #1 FREEBOARD: 5097.5 QUALITY TREATMENT $\overline{\text{LENGTH & WIDTH}} = 6'$ - GRAVEL POND ACCESS BOTTOM OF POND: 5091.75 2200 S VALENTIA ST FFE = 5099.00SIDE SLOPE: VERTICAL (WALLS) |MEDIAN D50 = 9"@ 10% MAX SLOPE **DENVER, CO 80231** TYPE L ROCK ″FG 93.50~ *NOTE: POND 2 INFORMATION IS SHOWN BASED ON PRELIMINARY RIPRAP PAD #2 LENGTH & WIDTH = 4.5' |REQ'D WQCV: 0.08 AC-FT CALCULATIONS ONLY. ACTUAL PROV'D WQCV: 0.088 AC-FT VOLUME AND LAYOUT SHALL BE TYPE 13 INLET-|MEDIAN D50 = 9"REQ'D 100 YR RETENTION VOL: 0.389 AC-FT DETERMINED BASED ON FUTURE RIM: 5096.80 TYPE L ROCK |PROV'D 100 YR RETENTION VOL: 0.391 AC-FT DEVELOPMENT CRITERIA AND TC 5098.63 IE OUT: 5083.80 18" E TOTAL RETENTION VOL AVAILABLE: 0.775 AC-FT (5096.5 CALCULATIONS. TOTAL WQ+100 YR VOL AVAILABLE: 0.863 AC-FT (5096.5 FG 98.50-FREEBOARD: 5097.5 5083.74 18" W TOP OF POND: 5096.5 MH RIM: 5097.30 -CHASE #3 6LF 18" HDPE @ 1.00% 100-YR WSEL: 5094.5 **YCP(N):** \$089.15 -CONCRETE COLLAR **BENCHMARK** BOTTOM OF POND: 5091.75 5092.48 24" S VCP(S): 5089.30 FL 5097.38 SIDE SLOPE: VERTICAL (WALLS) - RIPRAP PAD #1 FOUND ALUMINUM CAP STAMPED "17468" LOCATED AT THE INTERSECTION OF E -WATER QUALITY FOREBAY 96TH AVE AND YOSEMITE ST. TC 5097.55 -#1 12LF 24" HDPE @ 1.00% L 5098.38 FL 5097.55 SW 98.15 FL 5097.05 NAVD 88 ELEVATION = 5097.985TW 96.50-[✓] W 98.33 BW 98.35 FL 5099.46 \mathbf{C} TC 5098.46 SW 98.25 →ME 99.58 EOP 00.08√ SW 98.00 L 5097.96 FL 5099.63 SW 97.91 FL 97.64 BASIS OF BEARING, BENCHMARK, 8836 E 96TH AVE R0188152 FL 97.47-WATERS OF THE STATE TC 5098.21 \TC 5098.14 ′ TC 5097.92 / C 5098.99 🔌 FL 5098.49 FL 5097.64 L 5097.71 FI 5097 42 8' CROSS PAN--8' CROSS PAN THE BASIS OF BEARINGS FOR THIS PLAN IS THE NORTH LINE OF THE NORTHEAST 1/4 OF SECTION 21, 8' CROSS TOWNSHIP 2 SOUTH, RANGE 67 WEST OF THE 6TH PRINCIPAL MERIDIAN AS EVIDENCED BY A FOUND 3.25" FL 5098.57 EOP 98.42 PAN @ 0.5% ALUMINUM CAP "LS 17468" BEING THE NORTHEAST 1/4 CORNER OF SAID SECTION 21 FROM WHENCE A EOP 97.92-EOP 00.56~ FOUND 3.25" ALUMINUM CAP "ILLEGIBLE" BEING THE NORTH 1/4 CORNER OF SAID SECTION 21 BEARS SOUTH 89'40'37" WEST. A DISTANCE OF 2641.08 FEET WITH ALL BEARINGS HEREIN RELATIVE THERETO. EOP 98.23 RIM: 5097.82 WATERS OF THE STATE: PROJECT DOES NOT OUTLET STORMWATER INTO THE WATERS OF THE STATE. ■~SW 98.80 TC 5100.44 FL: 5097.07 48" SDMH-NEAREST WATERS OF THE STATE WOULD BE LOCATED APPROXIMATELY 3,000 LF TO THE EAST OF THE SITE L 5099.94 IE IN: 5092.70 24" S RIM: 5098.15 AND IS LABELED AS FIRST CREEK, WHICH DRAINS TOWARDS BARR LAKE. IE OUT: 5093.06 24" N IE OUT: 5092.60 24" N SUBMITTAL ME 98.70~ -#2 36LF 24" HDPE @ 1.00% **DEVELOPMENT PLAN** TC 5098 84 FL 5098.34 DRAWN BY: CHECKED BY: CUT FILL AREAS SHOWN ON PLAN ARE APPROXIMATE. CONTRACTOR TO VERIFY. 20-143-001 PROJECT NO. CUT: 1761 CU. YD. FILL: 939 CU. YD. REVISIONS COMMENTS 1/5/22 COMMENTS 5/17/22 COMMENTS 9/15/22 COMMERCE CITY GRADING NOTES THE CONTRACTOR SHALL NOTIFY THE CITY 48 HOURS PRIOR TO COMMENCING GRADING. THE FOLLOWING GENERAL NOTES SHOULD BE INCLUDED ON THE GRADING PLANS WHEN APPLICABLE: START OF CONSTRUCTION. THE CITY STRONGLY ENCOURAGES THE APPLICANT TO HAVE THE ENGINEER OF RECORD AT THE PRECONSTRUCTION MEETING GRADING PLAN IS FOR ROUGH GRADING ONLY. CHANGES MAY BE NECESSARY TO BRING PLANS INTO CONFORMANCE WITH APPROVED DRAINAGE AND SITE PLAN. 20. CONSTRUCTION SHALL NOT BEGIN UNTIL THE CITY ESC INSPECTOR APPROVES THE INSTALLATION OF THE INITIAL BMP'S AND THE GRADING PERMIT IS OBTAINED FROM PUBLIC WORKS. A WATER TRUCK SHALL BE KEPT ON-SITE TO CONTROL WIND EROSION AND DUST. 21. THE ESC MANAGER SHALL STRICTLY ADHERE TO THE APPROVED LIMITS OF CONSTRUCTION AT ALL TIMES. THE CITY OF COMMERCE CITY ENGINEERING DIVISION MUST APPROVE ANY CHANGES TO THE LIMITS OF ANY SETTLEMENT OR SOIL ACCUMULATIONS BEYOND THE PROPERTY LIMITS DUE TO GRADING OR EROSION SHALL BE REPARIED IMMEDIATELY BY THE CONTRACTOR. CONSTRUCTION AND, AT THE DISCRETION OF THE ENGINEERING DIVISION, ADDITIONAL EROSION/SEDIMENT CONTROLS MAY BE REQUIRED IN ANY ADDITIONAL AREAS OF CONSTRUCTION. NO GRADING SHALL TAKE PLACE IN ANY DELINEATED FLOOD HAZARD AREA UNTIL THE FINAL DRAINAGE PLAN HAS BEEN APPROVED AND ALL APPROPRIATE PERMITS HAVE BEEN OBTAINED. 22. NATURAL VEGETATION SHALL BE RETAINED AND PROTECTED WHEREVER POSSIBLE. EXPOSURE OF SOIL TO EROSION BY REMOVAL OR DISTURBANCE OF VEGETATION SHALL BE LIMITED TO THE AREA REQUIRED ANY CONSTRUCTION DEBRIS OR MUD TRACKING IN THE PUBLIC RIGHT-OF-WAY RESULTING FROM THIS DEVELOPMENT WILL BE REMOVED IMMEDIATELY BY THE CONTRACTOR. UPON WRITTEN NOTICE BY THE CITY, FOR IMMEDIATE CONSTRUCTION OPERATIONS. FAILURE TO REMOVE THE MUD OR DEBRIS BY THE CONTRACTOR WITHIN 24 HOURS SHALL CAUSE THE CITY TO STOP ALL WORK UNTIL THE SITUATION IS RESOLVED. 23. A COPY OF THE GRADING PERMIT AND APPROVED PLANS SHALL BE ON SITE AT ALL TIMES. WHEN REQUIRED, A COLORADO DEPARTMENT OF PUBLIC HEALTH AND ENVIRONMENT (CDPHE), WATER QUALITY DIVISION, STORMWATER DISCHARGE PERMIT SHALL BE OBTAINED AND A COPY SHALL BE SUBMITTED 24. THE ESC MANAGER SHALL BE RESPONSIBLE FOR ENSURING THAT THE SITE REMAINS IN COMPLIANCE AND SHALL BE THE PERMITTEE'S CONTACT PERSON WITH THE CITY FOR ALL MATTERS PERTAINING TO THE TO THE CITY OF COMMERCE CITY DEPARTMENT OF PUBLIC WORKS. GRADING PERMIT. THE ESC MANAGER SHALL BE PRESENT AT THE SITE THE MAJORITY OF THE TIME AND SHALL BE AVAILABLE THROUGH A 24-HOUR CONTACT NUMBER. 7/23/2021 AREAS DISTURBED BY GRADING SHALL BE MULCHED AND RESEEDED WITH NATIVE VEGETATION OR AS APPROVED ON THE PLAN. 25. THE ESC MANAGER IS RESPONSIBLE FOR CLEANUP OF SEDIMENT OR CONSTRUCTION DEBRIS TRACKED ONTO ADJACENT PAVED AREAS, PAVED AREAS, INCLUDING STREETS, ARE TO BE KEPT CLEAN THROUGHOUT 8. THE CONTRACTOR SHALL BE SOLELY AND COMPLETELY RESPONSIBLE FOR SAFETY CONDITIONS ON AND ADJACENT TO THE SITE 24 HOURS A DAY, SEVEN DAYS A WEEK. BUILD-OUT AND SHALL BE CLEANED WITH A STREET SWEEPER OR SIMILAR DEVICE AT FIRST NOTICE OF ACCIDENTAL TRACKING OR AT THE DISCRETION OF THE CITY'S ESC INSPECTOR. STREET WASHING IS NOT CONTRACTOR SHALL CONTACT UTILITY NOTIFICATION CENTER FOR THE LOCATION OF UNDERGROUND UTILITIES AT LEAST 48 HOURS PRIOR TO COMMENCEMENT OF CONSTRUCTION. (811 OR 1-800-922-1987) ALLOWED. THE CITY RESERVES THE RIGHT TO REQUIRE ADDITIONAL MEASURES TO ENSURE AREA STREETS ARE KEPT FREE OF SEDIMENT AND/OR CONSTRUCTION DEBRIS. 10. THE CITY ENGINEER'S SIGNATURE AFFIXED TO THIS DOCUMENT INDICATES THE CITY OF COMMERCE CITY PUBLIC WORKS DEPARTMENT, ENGINEERING DIVISION, HAS REVIEWED THE DOCUMENT AND FOUND IT IN 26. THE APPROVED PLANS MAY REQUIRE CHANGES OR ALTERATIONS AFTER APPROVAL TO MEET CHANGING SITE OR PROJECT CONDITIONS OR TO ADDRESS INEFFICIENCIES IN DESIGN OR INSTALLATION. ALL GENERAL COMPLIANCE WITH THE CITY'S STORMWATER QUALITY CONTROL CRITERIA. THE CITY ENGINEER, THROUGH ACCEPTANCE OF THIS DOCUMENT, ASSUMES NO RESPONSIBILITY (OTHER THAN AS STATED CONSTRUCTION TRAFFIC MUST ENTER/EXIT THE SITE THROUGH THE CITY APPROVED ACCESS POINTS. A VEHICLE TRACKING CONTROL PAD IS REQUIRED AT ALL ACCESS POINTS ON THE SITE. ADDITIONAL ABOVE) FOR THE COMPLETENESS AND/OR ACCURACY OF THESE DOCUMENTS. STABILIZED CONSTRUCTION ENTRANCÉS MAY BE ADDED WITH AUTHORIZATION FROM THE COMMERCE CITY ENGINEERING DIVISION. **GRADING AND** 11. THE ADEQUACY OF THIS ESC PLAN LIES WITH THE ORIGINAL DESIGN ENGINEER. 27. THE ESC MANAGER SHALL OBTAIN PRIOR APPROVAL FROM THE DESIGN ENGINEER AND COMMERCE CITY ENGINEERING DIVISION FOR ANY PROPOSED CHANGES. 12. ALL MATERIALS AND WORKMANSHIP SHALL BE SUBJECT TO INSPECTION BY THE CITY. COMMERCE CITY RESERVES THE RIGHT TO ACCEPT OR REJECT ANY SUCH MATERIALS AND WORKMANSHIP THAT DOES NOT 28. NO PERMANENT EARTH SLOPES GREATER THAN 3:1 SHALL BE ALLOWED. NORT DRAINAGE 29. ANY SETTLEMENT OR SOIL ACCUMULATIONS BEYOND THE LIMITS OF CONSTRUCTION DUE TO GRADING OR EROSION SHALL BE REPAIRED IMMEDIATELY BY THE ESC MANAGER. THE ESC MANAGER SHALL BE HELD RESPONSIBLE FOR OBTAINING ACCESS RIGHTS TO ADJACENT PROPERTY, IF NEEDED, AND REMEDIATING ANY ADVERSE IMPACTS TO ADJACENT WATERWAYS, WETLANDS, PROPERTIES, ETC. RESULTING FROM WORK 13. THE PLACEMENT OF EROSION AND SEDIMENT CONTROL BEST MANAGEMENT PRACTICES (BMP'S) SHALL BE IN ACCORDANCE WITH THE CITY APPROVED PLANS. PLAN 14. ANY VARIATION IN MATERIAL, TYPE OR LOCATION OF EROSION AND SEDIMENT CONTROL BMP'S FROM THE CITY APPROVED PLANS WILL REQUIRE APPROVAL FROM AN ACCOUNTABLE REPRESENTATIVE OF THE 30. SOILS THAT WILL BE STOCKPILED FOR MORE THAN THIRTY (30) DAYS SHALL BE SEEDED AND MULCHED WITHIN FOURTEEN (14) DAYS OF STOCKPILE CONSTRUCTION. NO STOCKPILES SHALL BE PLACED WITHIN CITY OF COMMERCE CITY ENGINEERING DIVISION. 15. AFTER THE ESC PLAN HAS BEEN APPROVED, THE CONTRACTOR MAY INSTALL THE INITIAL-STAGE EROSION AND SEDIMENT CONTROL BMPS INDICATED ON THE ACCEPTED ESC PLAN. ONE HUNDRED (100) FEET OF A DRAINAGE WAY UNLESS APPROVED BY THE COMMERCE CITY ENGINEERING DIVISION. 1 inch = 20 ft.SHEET INFORMATION 16. THE FIRST BMP TO BE INSTALLED ON THE SITE SHALL BE CONSTRUCTION FENCE, MARKERS, OR OTHER APPROVED MEANS OF DEFINING THE LIMITS OF CONSTRUCTION, INCLUDING CONSTRUCTION LIMITS 31. ALL CHEMICAL OR HAZARDOUS MATERIAL SPILLS WHICH MAY ENTER WATERS OF THE STATE OF COLORADO, WHICH INCLUDE BUT ARE NOT LIMITED TO, SURFACE WATER, GROUND WATER AND DRY GULLIES OR ADJACENT TO STREAM CORRIDORS AND OTHER AREAS TO BE PRESERVED. STORM SEWER LEADING TO SURFACE WATER, SHALL BE IMMEDIATELY REPORTED TO THE CDPHE PER CRS 25-8-601, AND COMMERCE CITY. RELEASES OF PETROLEUM PRODUCTS AND CERTAIN HAZARDOUS CITY STAFF CERTIFICATE: 17. AFTER INSTALLATION OF THE INITIAL-STAGE EROSION AND SEDIMENT CONTROL BMPS, THE PERMITTEE SHALL CALL THE PUBLIC WORKS AT 303-289-8150 TO SCHEDULE A PRECONSTRUCTION MEETING AT THE SUBSTANCES LISTED UNDER THE FEDERAL CLEAN WATER ACT (40 CFR PART 116) MUST BE REPORTED TO THE NATIONAL RESPONSE CENTER. SOUTH ADAMS COUNTY WATER AND SANITATION DISTRICT AS WELL PROJECT SITE. THE REQUEST SHALL BE MADE A MINIMUM OF THREE BUSINESS DAYS PRIOR TO REQUESTED MEETING TIME. NO CONSTRUCTION ACTIVITIES SHALL BE PLANNED WITHIN 24 HOURS AS THE CDPHE. SPILLS THAT POSE AN IMMEDIATE RISK TO HUMAN LIFE SHALL BE REPORTED TO 911. FAILURE TO REPORT AND CLEAN UP ANY SPILL SHALL RESULT IN ISSUANCE OF A STOP WORK ORDER. APPROVED BY THE DEPARTMENT OF COMMUNITY DEVELOPMENT OF THE CITY OF AFTER THE PRECONSTRUCTION MEETING. 32. THE CLEANING OF CONCRETE DELIVERY TRUCK CHUTES IS RESTRICTED TO APPROVED CONCRETE WASH OUT LOCATIONS ON THE JOB SITE. THE DISCHARGE OF WATER CONTAINING WASTE CONCRETE TO THE 18. THE ESC MANAGER SHALL BE CERTIFIED IN STORMWATER MANAGEMENT AND EROSION CONTROL AND DOCUMENTATION SHALL BE PROVIDED TO THE CITY. COMMERCE CITY, THIS _____ DAY OF _____ A.D. ____ STORM SEWER SYSTEM IS PROHIBITED. ALL CONCRETE WASTE SHALL BE PROPERLY CLEANED UP AND DISPOSED AT AN APPROPRIATE LOCATION. 19. THE OWNER OR OWNER'S REPRESENTATIVE. THE ESC MANAGER, THE GENERAL CONTRACTOR, AND THE GRADING SUBCONTRACTOR, IF DIFFERENT FROM THE GENERAL CONTRACTOR, MUST ATTEND THE 33. COMMERCE CITY DOES NOT ALLOW HAY BALES AS A FORM OF EROSION AND SEDIMENT CONTROL. PRECONSTRUCTION MEETING. IF ANY OF THE REQUIRED PARTICIPANTS FAIL TO ATTEND THE PRECONSTRUCTION MEETING, OR IF THE INSTALLATION OF THE INITIAL BMP'S ARE NOT APPROVED BY THE CITY ESC 34. ONCE THE SITE HAS REACHED FINAL STABILIZATION, A FINAL INSPECTION SHALL BE SCHEDULED WITH THE CITY'S ESC INSPECTOR. A CERTIFICATE OF OCCUPANCY WILL NOT BE ISSUED AND/OR THE GRADING Of INSPECTOR, THE APPLICANT WILL HAVE TO PAY A REINSPECTION FEE, ADDRESS ANY PROBLEMS WITH BMP INSTALLATION, AND CALL TO RESCHEDULE THE MEETING, WITH A CORRESPONDING DELAY IN THE BOND WILL NOT BE RELEASED UNTIL THE CITY'S ESC INSPECTOR APPROVES FINAL STABILIZATION DEPARTMENT OF COMMUNITY DEVELOPMENT SIGNATURE

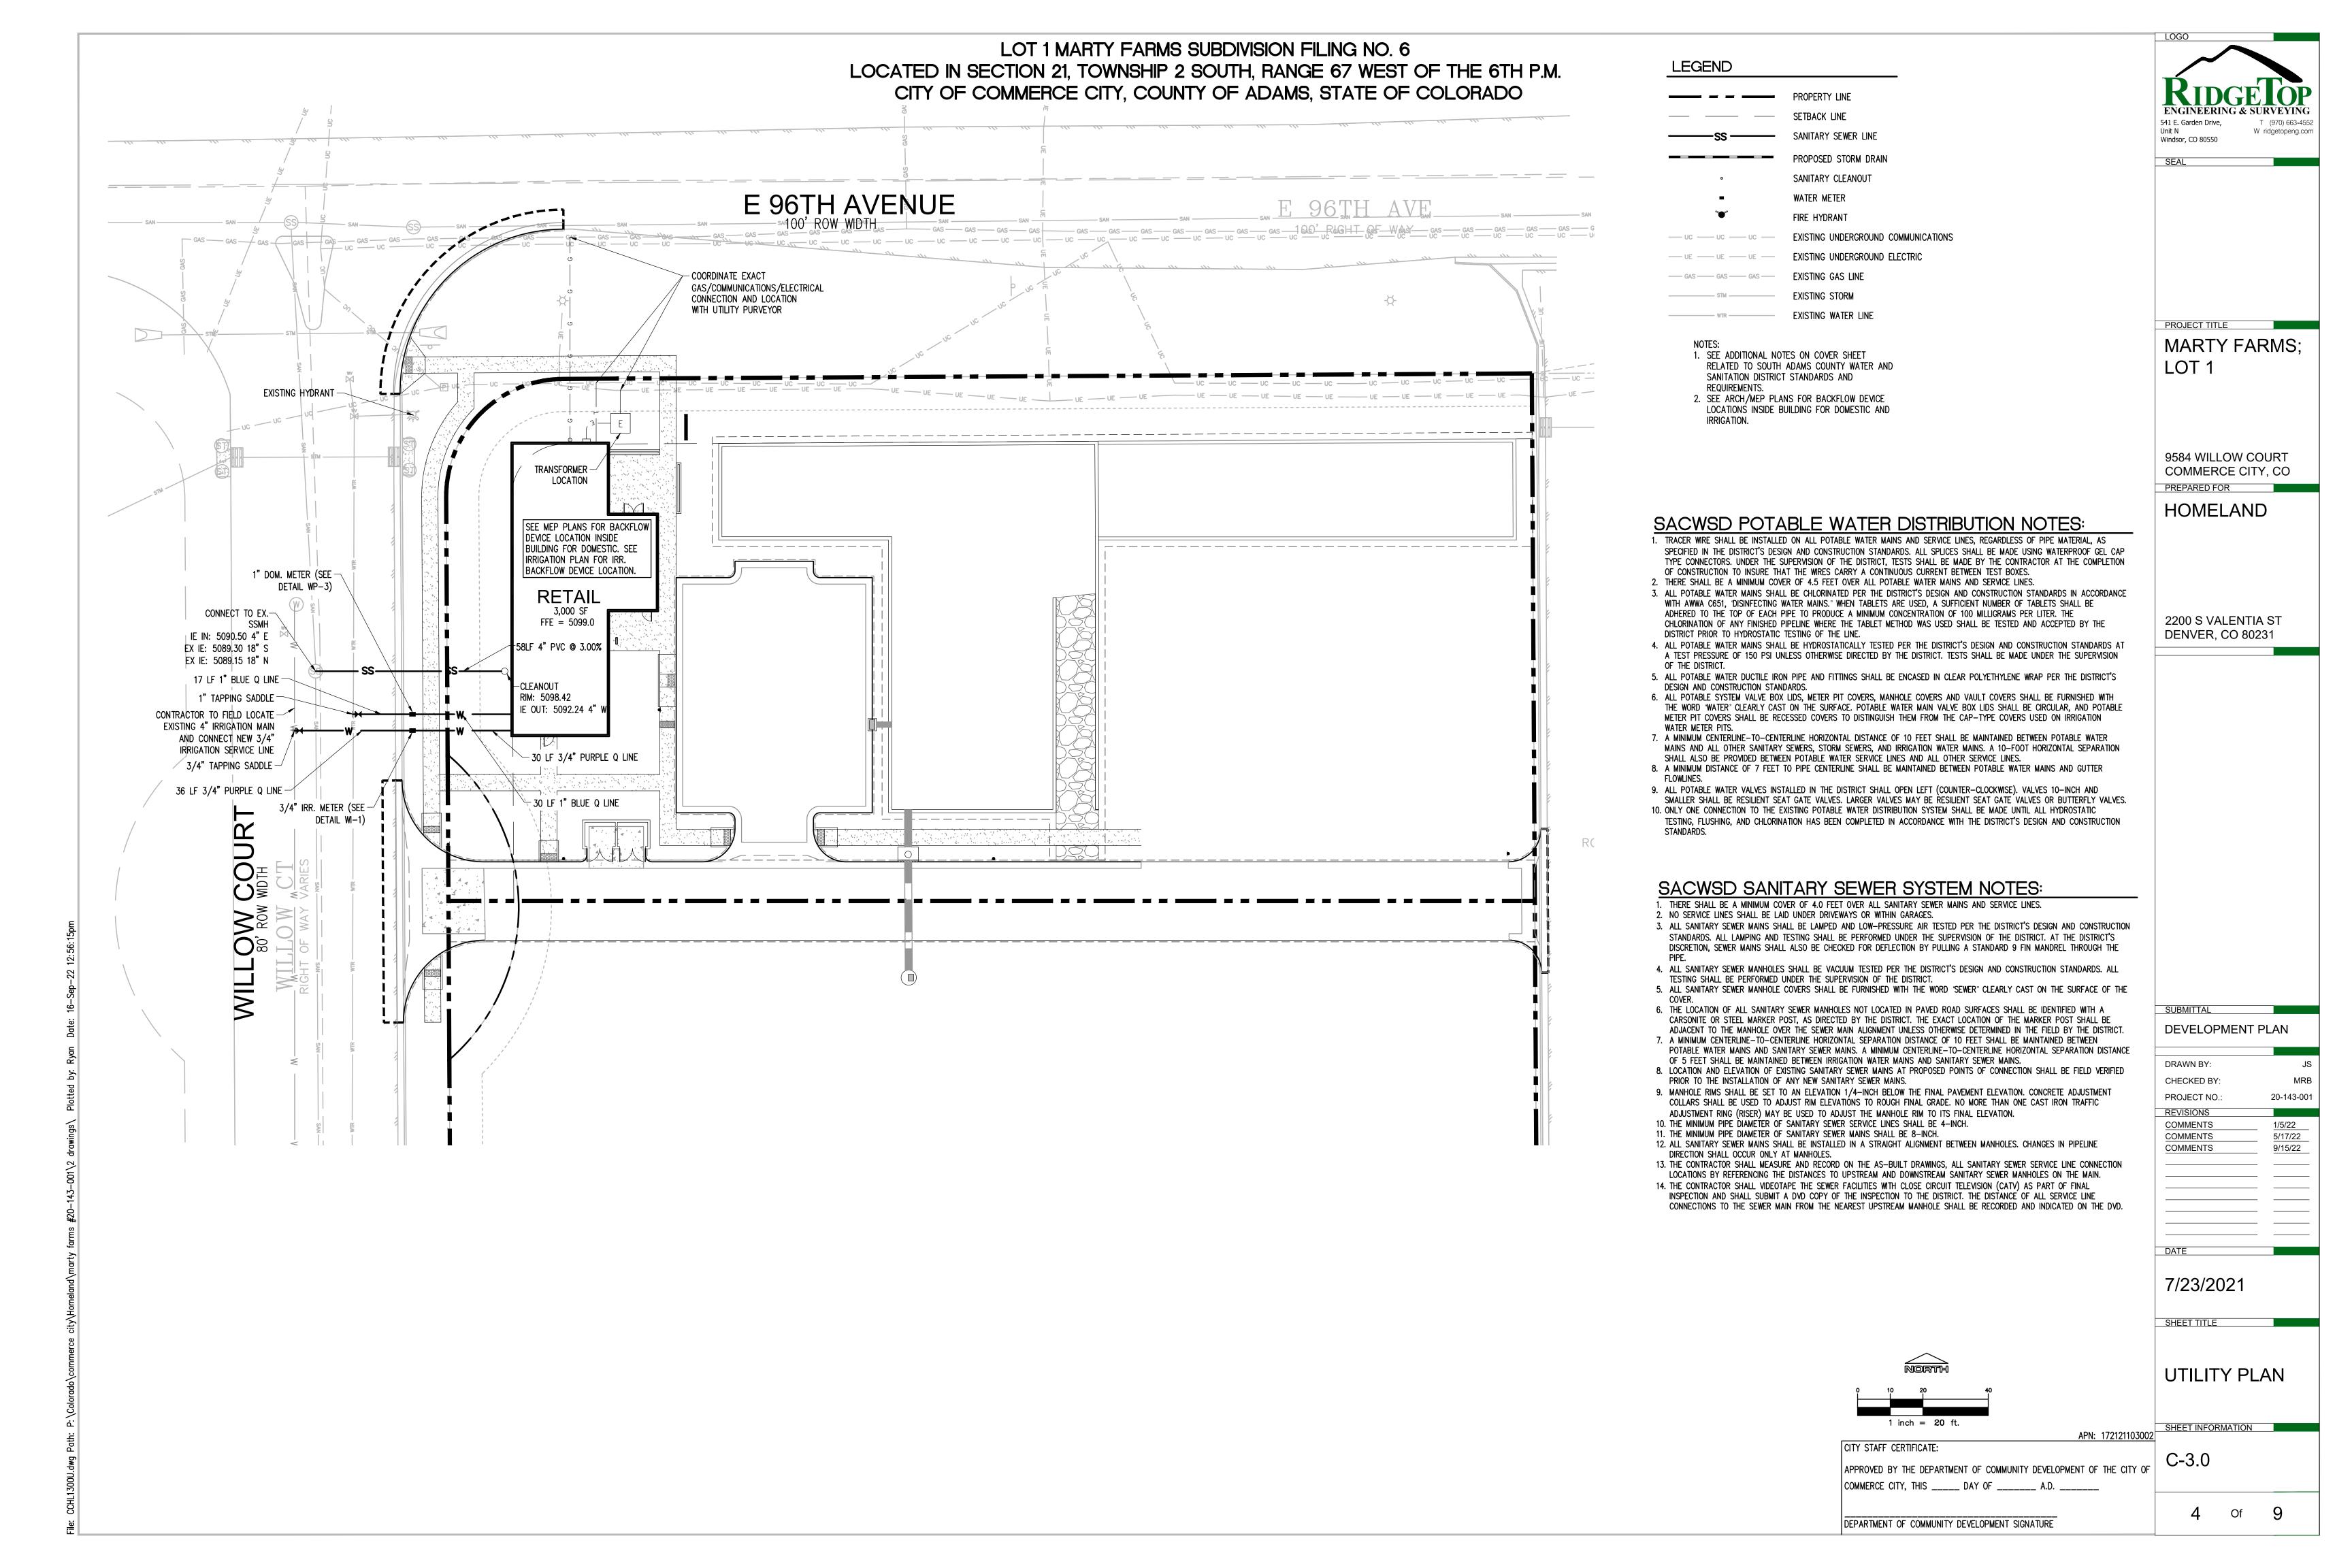

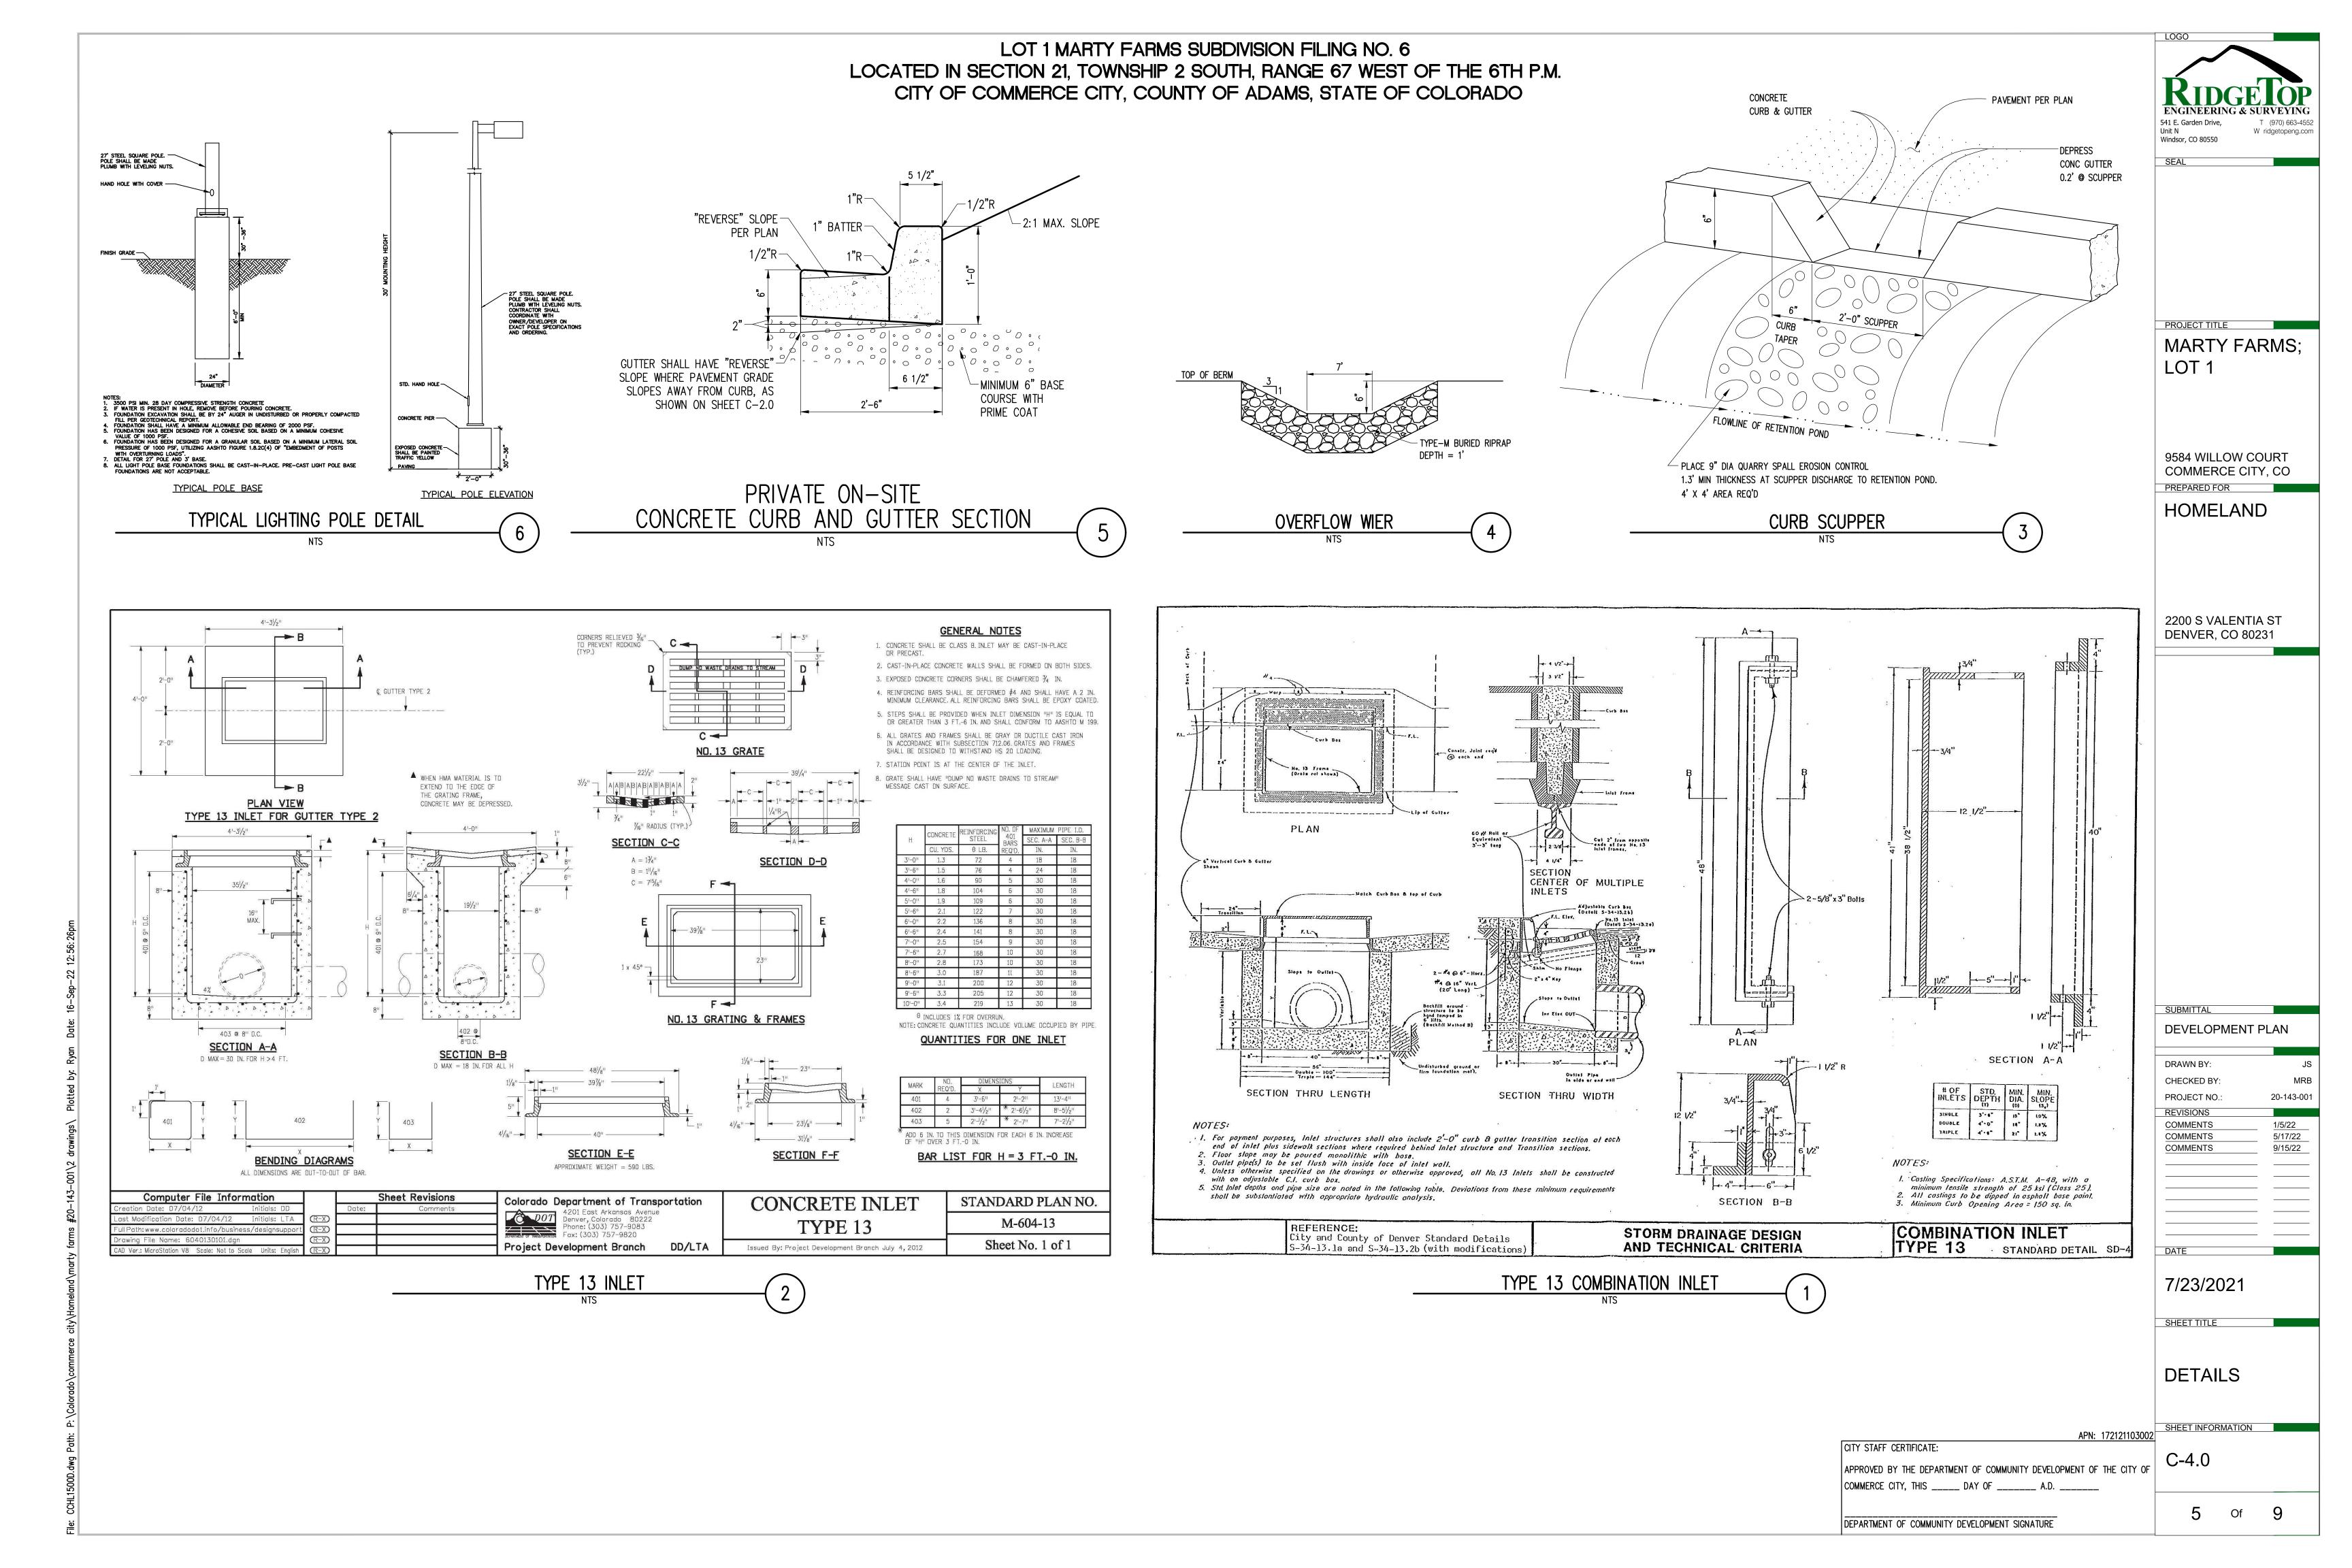

LOT 1 MARTY FARMS SUBDIVSION FILING NO. 6 LOCATED IN SECTION 21, TOWNSHIP 2 SOUTH, RANGE 67 WEST OF THE 6TH P.M. COMMERCE CITY, COUNTY OF ADAMS, STATE OF COLORADO



ADVANCE BEFORE YOU DIG, GRADE, OR EXCAVATE FOR THE MARKING OF UNDERGROUND MEMBER UTILITIES.






Landscape Architect:

Owner / Client:



ARCHITECTURE **Jump Design Company** 1733 S. Clarkson Street Denver, Colorado 80210 303.282.0463 fax 282.0473

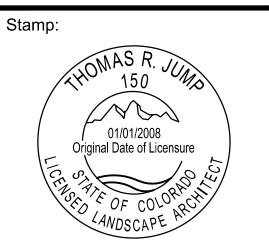

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Issue Date	09/16/22
Revisions	


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Sheet Title

LANDSCAPE PLAN

Sheet No.

1 of 2

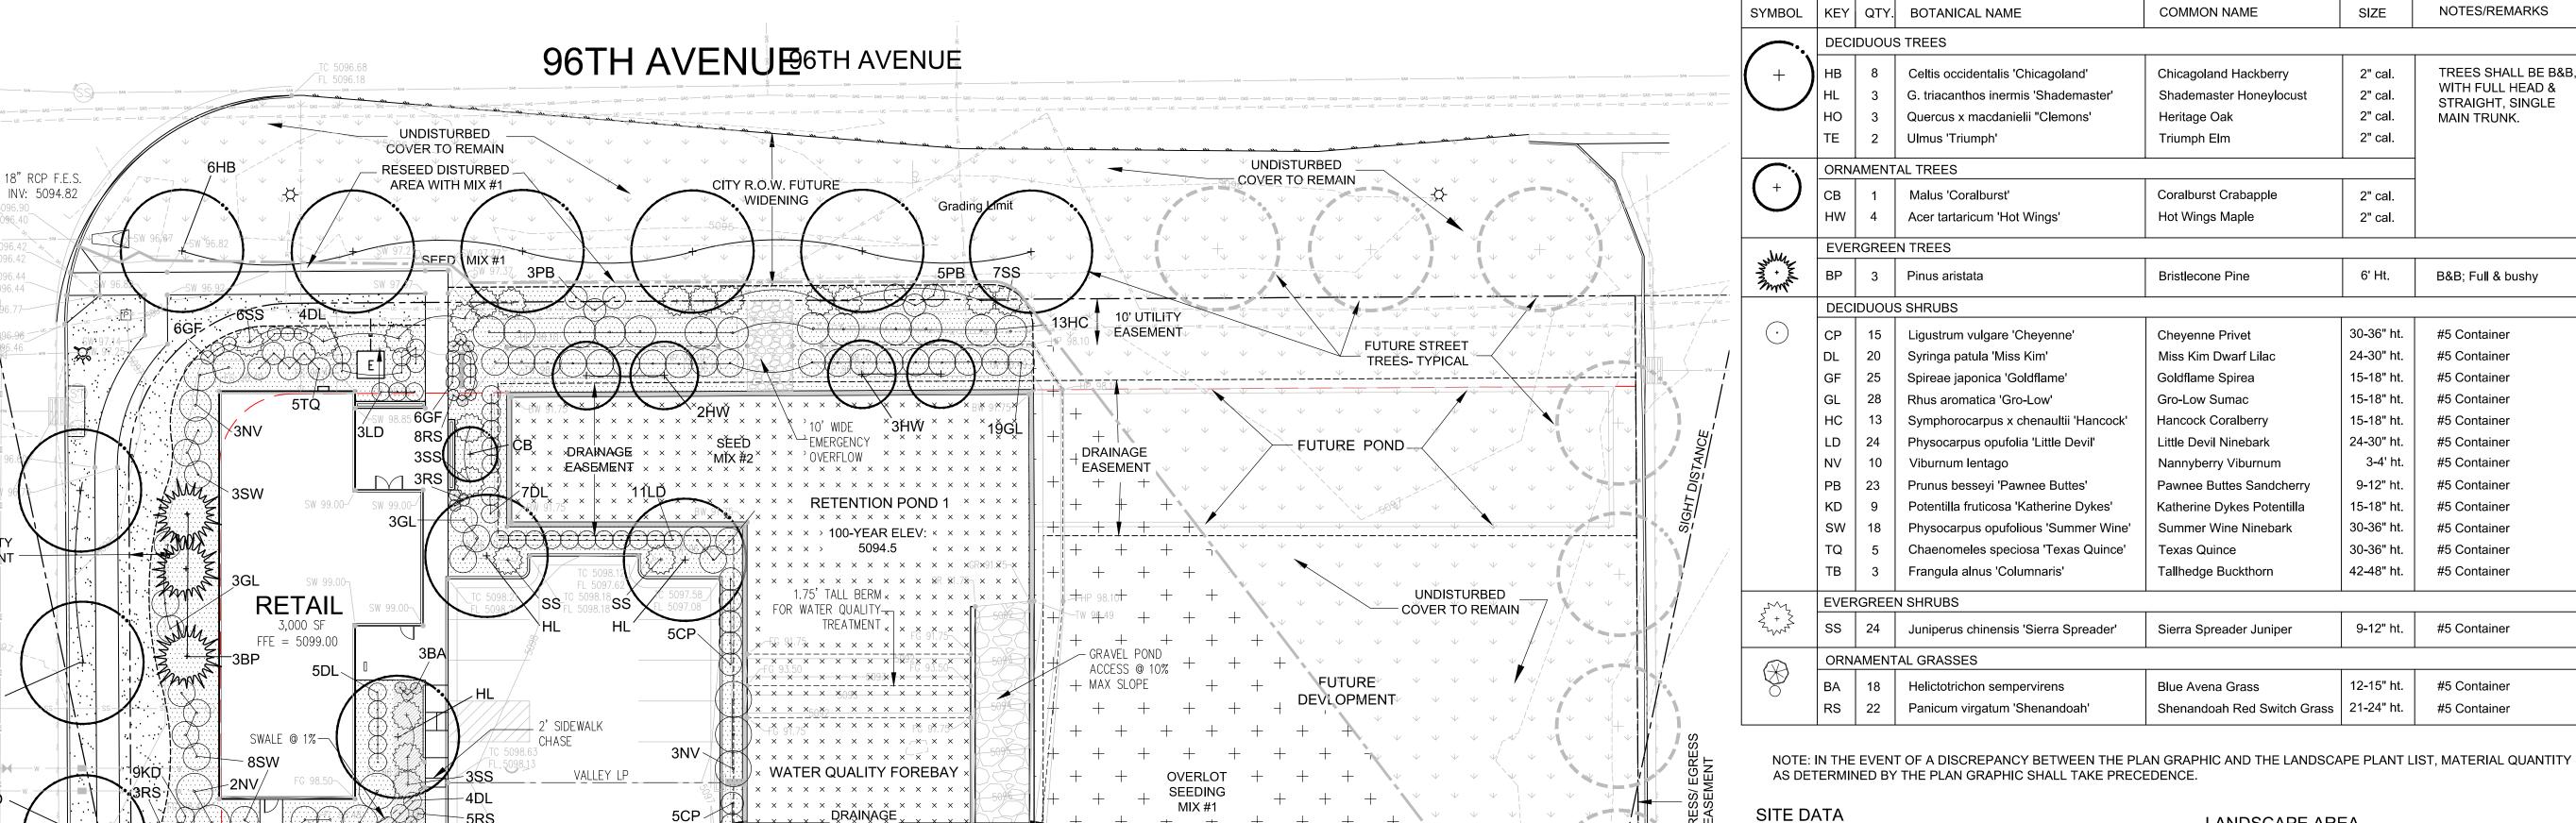

MIX #1: PERMANENT DRILL SEEDING MIX- OVERLOT

3GF

10' UTILITY

EASEMENT

25' SIGHT 2

TRIANGLE

WINCH THE COLUMN				
COMMON NAME	BOTANIC NAME	VARIETY	% MIX	# P.L.S. PER AC
BIG BLUESTEM	BOUTELOUA DACTYLOIDES	'KAW'	10%	2.5
YELLOW INDIANGRASS	BOUTELOUA GRACILIS	'CHEYENNE'	10%	2.5
SWITCHGRASS	PASCOPYRUM SMITHII	'BLACKWELL'	10%	2.5
SIDEOATS GRAMA	BOUTELOU CURTIPENDULA	'VAUGHN'	10%	2.5
WESTERN WHEATGRASS	AGROPYRON SMITHII	'ARRIBA'	10%	2.5
BLUE GRAMA	BOUTELOUA GRACILIS	'HACITA'	10%	2.5
THICKSPIKE WHEATGRASS	ELYMUS LANCEOLATUS	'CRITANA'	10%	2.5
PRAIRIE SANDREED	CALAMOVILFA LONGIFOLIA	'GOSHEN'	10%	2.5
GREEN NEEDLEGRASS	NASSELLA VIRIDULA	'LODORM'	10%	2.5
SLENDER WHEATGRASS	ELYMUS TRACHYCAULUS	'PRYOR'	5%	1.25
STREAMBANK WHEATGRASS	ELYMUS LANCEOLATUS	'SODAR'	5%	1.25
	TOTAL LBS. PE	R ACRE (DRILL	ED)	25.0

POND ACCESS SEE CIVIL PLANS FFL 5098.49

SURFACE MATERIAL

SURFACE MATERIAL

SURFACE MATERIAL

(UDFCD RAIN GARDEN MIX)		
COMMON NAME	BOTANIC NAME	% MIX
SAND BLUESTEM	ANDROPOGON HALLII 'GARDEN'	12.2%

MIX #2: RETENTION POND BOTTOM SEEDING MIX

COMMON NAME	BOTANIC NAME	% MIX	# P.L.S. PER AC.
SAND BLUESTEM SIDEOATS GRAMA	ANDROPOGON HALLII 'GARDEN' BOUTELOUA CURTIPENDULA 'BUTTE'	12.2% 10.4%	3.5 3.0
PRAIRIE SANDREED	CALAMOVILFA LONGIFOLIA 'GOSHEN'	10.4%	3.0
INDIAN RICEGRASS	ORYZOPSISHYMENOIDES 'PALOMA'	10.4%	3.0
SWITCHGRASS	PANICUM VIRGATUM	13.8%	4.0
WESTERN WHEATGRASS	PASCOPYRUM SMITHII	10.4%	3.0
LITTLE BLUESTEM	SCHIZACHYRIUM SCOPARIUM	10.4%	3.0
ALKALI SACATON	SPOROBOLUS AIROIDES	10.4%	3.0
SAND DROPSEED	SPOROBOLUS CRYPTANDRUS	10.4%	3.0
PASTURE SAGE	ARTEMISIA FRIGIDA		2.0 oz.
BLUE ASTER	ASTER LAEVIS)	4.0 oz.
BLANKET FLOWER	GAILLARDIA ARISTATA	5.5% \prec	8.0 oz.
PRAIRIE CONEFLOWER	RATIBA COLUMNIFERA)	4.0 oz.
PURPLE PRAIRIECLOVER	DALEA PURPUREA		4.0 oz.
TOTAL LBS. PER ACRE (DRILLED)			28.9 lbs.

LEGEND SEEDING MIX #1- OVERLOT DECIDUOUS TREE ORNAMENTAL TREE SEEDING MIX #2- DETENTION **EVERGREEN TREE** IRRIGATED TURF DECIDUOUS SHRUB 4" DEPTH ROCK MULCH **EVERGREEN SHRUB** 4" DEPTH SHREDDED CEDAR UNDISTURBED COVER ORNAMENTAL GRASS STEEL EDGER ___ GRADING LIMITS ____

LANDSCAPE SUMMARY

LOT TOTAL SITE AREA:

BUILDING COVERAGE

HARDSCAPE

LANDSCAPE

UNDEVELOPED

PLANT LIST

LANDSCAPE TREATMENT AREA Total developed area 41,192 SF / .95 AC.	Quantity	Percentage of Total
a.) Total Landscape Area	17,193 SF	32.4%
b.) Living Plant Material	12,895 SF	75%
c.) # Trees Required (1/600 sf)	29	
d.) # Trees Provided	24	
e.) # Shrubs Required (1/300 sf)*	58	
f.) # Shrubs Provided	257	
g.) # of Mulch Types	2	

RETENTION POND	Quantity
a. Length of perimeter	337 LF
b.) # Trees Required (1 per 50 LF)	7
c.) # Trees Provided	7
d.) # Shrubs Required (10 per 50 LF)	68
e.) # Shrubs Provided	68

53,112 SF (1.12 Ac.)

3,150 SF (5.9%)

20,849 SF (39.2%)

17,193 SF (32.4%)

11,920 SF (22.5%)


LANDSCAPE AREA

_			
		PRIVATE	R.O.W.
Т	OTAL (DEVELOPED AREA)	17,193 SF	1,898 S
IF	RRIGATED BLUEGRASS TURF	1,248 SF (7.3%)	402 S
P	PLANTING BEDS	8,092 SF (47.1%)	
s	SEEDED AREA (RETENTION)	7,538 SF (43.8%)	
s	SEEDING (OTHER)	315 SF (1.8%)	
U	JNDISTURBED	11,920 SF	11,287

_			
	RIGHT-OF-WAY LANDSCAPE AREA	Length	Trees Req'd. / Prov'd.
	a.) ROW frontage- 96th Ave.	200 LF	5 / 6
	b.) ROW frontage- Willow Court	148 LF	4 / 3

	Percentage of Total
2	
2	
16	
27	
2	
2	
	2 16 27 2

SEE SHEET L1.1 FOR NOTES AND DETAILS.

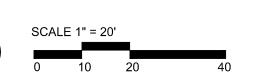

CITY STAFF CERTIFICATE:

APPROVED BY THE DEPARTMENT OF COMMUNITY DEVELOPMENT OF THE CITY OF COMMERCE CITY, THIS DAY OF

DEPARTMENT OF COMMUNITY DEVELOPMENT SIGNATURE

GUYING DETAIL

12 GA. IRON WIRE

GRADE

WITH 1/2" DIA.

EACH WIRE

DRIVEN FLUSH

WITH GRADE

WHITE PVC ON

CALL 811 2-BUSINESS DAYS IN ADVANCE BEFORE YOU DIG, GRADE, OR EXCAVATE FOR THE MARKING OF UNDERGROUND MEMBER UTILITIES.


Owner / Client: HOMELAND.COM

2200 S. Valentia Street Denver, CO 80231 (303) 909-2508

Landscape Architect:



PLANNING & LANDSCAPE ARCHITECTURE **Jump Design Company** 1733 S. Clarkson Street Denver, Colorado 80210 303.282.0463 fax 282.0473

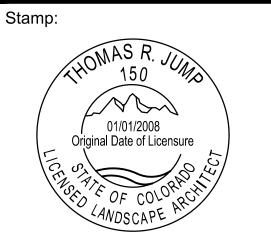

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09/16/22 Issue Date Revisions

Job #:

NOT TO SCALE

APPROVED BY THE DEPARTMENT OF COMMUNITY DEVELOPMENT OF THE CITY OF COMMERCE CITY, THIS _____ DAY OF _____, A.D. ____.

PLAN NOTES

1. ALL WORK SHALL CONFORM TO THE CITY OF COMMERCE CITY STANDARDS & REGULATIONS.

2. CONTACT APPROPRIATE UTILITY LOCATORS TO LOCATE OF ALL BURIED UTILITY LINES. FIELD-VERIFY EXISTING LOCATIONS. GRADES, AND CONDITIONS OF ALL BURIED UTILITIES PRIOR TO CONSTRUCTION. NOTIFY OWNER'S REPRESENTATIVE OF ANY CONFLICTS OR DISCREPANCIES FROM THESE PLANS. DAMAGE TO UTILITIES BY THE CONTRACTOR SHALL BE REPAIRED AT HIS OWN COST WITH NO EXPENSE TO THE OWNER.

3. VERIFY THE LOCATION OF ALL PERTINENT EXISTING & CONSTRUCTED SITE IMPROVEMENTS ALREADY INSTALLED PRIOR TO BEGINNING WORK. NOTIFY THE OWNER'S REPRESENTATIVE OF ANY CONFLICTS OR DISCREPANCIES FROM THE INFORMATION SHOWN ON THESE PLANS. IF DISCREPANCIES EXIST DO NOT PROCEED WITH CONSTRUCTION ACTIVITIES WITHOUT APPROVAL OF THE OWNER'S REPRESENTATIVE.

4. REFER TO THE ARCHITECTURAL, ENGINEERING, ELECTRICAL AND IRRIGATION PLANS COMPLETED BY OTHERS. ANY DISCREPANCIES THAT AFFECT THIS WORK MUST BE BROUGHT TO THE ATTENTION OF THE OWNER'S REPRESENTATIVE PRIOR TO CONSTRUCTION.

5. REFER TO THE CONSTRUCTION DRAWINGS DONE BY OTHER CONSULTANTS FOR GRADING AND ELEVATIONS. ENSURE POSITIVE DRAINAGE (2% MIN. FALL) AWAY FROM ALL BUILDING FOUNDATIONS IN ALL LANDSCAPE AREAS. NOTIFY OWNER'S REPRESENTATIVE IF ROUGH GRADING CONDITIONS WILL CREATE PONDING OR FLOW TOWARD FOUNDATIONS. ROUGH GRADES SHALL BE REVIEWED AND ACCEPTED BY OWNER'S REPRESENTATIVE PRIOR TO FINE GRADING AND SOIL PREPARATION OPERATIONS.

6. COORDINATE LOCATION OF IRRIGATION SLEEVING FOR INSTALLATION PRIOR TO PARKING AND WALK PAVING OPERATIONS. SEE IRRIGATION PLANS.

FINE GRADING / PREPARATION NOTES

7. LANDSCAPE OPERATIONS SHALL ACHIEVE FINISHED GRADES AS SHOWN ON THE CIVIL GRADING PLANS AFTER INSTALLATION. ALL COMPLETED LANDSCAPE AREAS SHALL DRAIN AT 2% MINIMUM SLOPE WITHOUT LOW SPOTS THAT POND. FINISH GRADES SHALL SLOPE AWAY FROM STRUCTURES AT THE RECOMMENDED SLOPES INDICATED IN THE PROJECT GEOTECHNICAL/ SOILS REPORT UNLESS SPECIFICALLY APPROVED BY THE CIVIL ENGINEER AND OWNER.

8. THE LANDSCAPE CONTRACTOR SHALL REVIEW THE COMPLETED ROUGH GRADING OPERATIONS PRIOR TO BEGINNING WORK AND NOTIFY THE OWNER'S REPRESENTATIVE OF ANY DISCREPANCIES BETWEEN THE GRADING PLANS AND ACTUAL CONDITIONS.

9. ALL LANDSCAPE AREAS SHALL BE FINE GRADED TO .10" +/- RESULTING IN A SMOOTH FINISH WITHOUT DEBRIS, DELETERIOUS MATERIALS OR CLODS OVER 1" DIAMETER. ALL FINE GRADING MUST BE APPROVED BY THE OWNER'S REPRESENTATIVE PRIOR TO LANDSCAPE INSTALLATION.

10. TO THE MAXIMUM EXTENT FEASIBLE, TOPSOIL THAT IS REMOVED DURING CONSTRUCTION ACTIVITY SHALL BE CONSERVED FOR LATER USE ON AREAS REQUIRING REVEGETATION AND LANDSCAPING. COORDINATE WITH GENERAL CONTRACTOR. THE TOP 4" OF LANDSCAPE AREAS SHALL BE EXISTING OR IMPORTED TOPSOIL AS NECESSARY.

11. SOIL AMENDMENT SHALL BE LOW-SALTS, FULLY-MATURED & NITROGEN STABILIZED ORGANIC COMPOST, CERTIFIED FREE OF PATHOGENS. pH SHALL BE 6.0 TO 7.4 WITH A MIN. OF 30% ORGANIC MATERIAL. COMPOST SHALL BE BIOCOMP-CLASS 1 BY A1 ORGANICS 16350 WCR 76, EATON, CO 80615, OR APPROVED EQUAL. AMENDMENT FOR LANDSCAPE AREAS SHALL BE 4 C.Y. PER 1,000 S.F

12. THE TOP 5" OF SUBGRADE SHALL BE TOPSOIL AND SOIL AMENDMENT MIXTURE TILLED TO A MIN. DEPTH OF 6" BELOW SUBGRADE

13. IN ALL BED AREAS HOLD TOP OF SUBGRADE 3-4" BELOW ADJACENT IMPROVEMENTS TO ALLOW

PLANTING NOTES

FOR SPECIFIED MULCH DEPTH.

14. PLANTS SHALL SHALL BE TRUE TO TYPE & SPECIES, HAVE SIMILAR SIZE & FORM AMONG THE SAME SPECIES AND MEET THE MINIMUM STANDARDS OUTLINED IN THE "AMERICAN STANDARD FOR NURSERY STOCK" ANSI Z60.1 (2014).

15. ALL PLANT MATERIALS SHALL BE HEALTHY, FREE OF PESTS, DISEASES AND BROKEN CONTAINERS AND ROOT BALLS. TREES SHALL HAVE SINGLE LEADERS UNLESS OTHERWISE SPECIFIED AND ROBUST BRANCHING AND FOLIAGE. ALL PLANTS ARE ARE SUBJECT TO APPROVAL BY THE OWNER'S REPRESENTATIVE- PLANTS NOT MEETING THE SET STANDARDS WILL BE REJECTED.

16. PLANT SPECIES AND LOCATIONS SHOULD FOLLOW THE APPROVED PLAN. IF SITE CONDITIONS OR PLANT AVAILABILITY REQUIRE CHANGES TO THE PLAN. THE CONTRACTOR MUST OBTAIN APPROVAL FROM THE CITY AND THE OWNER'S REPRESENTATIVE. SUBSTITUTIONS SHALL BE SUBMITTED PRIOR TO BIDDING AND REQUESTED SPECIES SHALL MATCH THE SPECIFIED PLANT'S MATURE SIZE & FORM.

17. ALL PLANT MATERIAL SHALL CARRY A WARRANTY FOR A PERIOD OF NOT LESS THAN 1 YEAR AFTER ACCEPTANCE OF THE PROJECT BY THE OWNER. WARRANTY SHALL BE A ONE-TIME, POST-FINAL ACCEPTANCE REPLACEMENT THAT INCLUDES PLANT MATERIAL AND LABOR COSTS. PLANTS NEEDED REPLACED PRIOR TO ACCEPTANCE WILL NOT APPLY TOWARD WARRANTY

18. LAYOUT PLANT LOCATIONS FOR APPROVAL PRIOR TO INSTALLATION. TREE LOCATIONS SHALL BE NO CLOSER THAN 3' FROM ALL CURBS & WALKWAYS EXCEPT FOR PARKING ISLANDS.

19. PLANT QUANTITIES SHOWN SYMBOLICALLY ON THE PLAN SHALL TAKE PRECEDENT AND BE INSTALLED OVER THOSE TOTALS IN THE PLANT LIST.

20. PLANT HOLE BACKFILL SHALL BE 1/3 TOPSOIL, 1/3 COMPoSTED AMENDMENT AND 1/3 NATIVE SOIL THOROUGHLY MIXED.

21. ALL SHRUBS & GRASSES SHALL RECEIVE SCOTT'S AGRIFORM SLOW-RELEASE FERTILIZER TABLETS APPLIED AT MANUFACTURER RECOMMENDED RATES.

EDGER

22. LAYOUT BED LINES FOR APPROVAL PRIOR TO INSTALLATION. ALL PLANTING BEDS ARE TO BE CONTAINED WITH MINIMUM 4" HEIGHT STEEL EDGER WITH ROLLED TOP AND NO EXPOSED SHARP EDGES. EDGER SHALL BE EXPOSED 1/2" MAXIMUM ABOVE FINISHED SURFACES. EDGER IS NOT REQUIRED WHEN ADJACENT TO CURBS, WALLS OR WALKS.

23. EDGER SHALL BE PRO-STEEL PS3/16-16, 4" DEPTH x 3/16" (7 GA.) WITH STAKES AND FASTENED OVERLAP SECTIONS PER MANUFACTURER'S RECOMMENDATIONS. SUPPLIER SHALL BE PRO-STEEL EDGING & LANDSCAPE PRODUCTS, 5121 KALTENBRUN RD., FORT WORTH, TX 76119 OR APPROVED

WEED BARRIER & MULCH

24. INSTALL DEWITT PRO-5 WEED BARRIER FABRIC OR APPROVED EQUAL UNDER ALL ROCK BEDS DO NOT INSTALL WEED BARRIER BELOW SHREDDED RED CEDAR WOOD MULCH BEDS.

25. PLANTING BEDS SHALL BE MULCHED WITH 3/4" CRUSHED GRANITE MULCH, 'COLORADO RED' FROM PIONEER LANDSCAPE SUPPLY OR APPROVED EQUAL OVER LANDSCAPE FILTER FABRIC. ALL PLANTS IN ROCK MULCH BEDS SHALL HAVE 3-4" DEPTH RING OF DOUBLE-SHREDDED RED CEDAR MULCH ABOVE EACH PLANTING PIT AT 1.5 TIMES THE CONTAINER DIAMETER. MULCH & ROCK COLOR SHALL BE APPROVED BY OWNER PRIOR TO INSTALLATION.

26. ALL BEDS DESIGNATED AS WOOD MULCH SHALL HAVE NATURAL DOUBLE-SHREDDED RED CEDAR MULCH AT 3-4" DEPTH WITHOUT WEED FABRIC. TREES IN SEEDED OR SODDED AREAS SHALL ALSO HAVE DOUBLE-SHREDDED RED CEDAR MULCH RINGS OF AT LEAST 3-4' IN DIAMETER

27. SOD SHALL BE 'REVEILLE' HYBRID TEXAS/KENTUCKY BLUEGRASS (POA ARACHNIFERA X POA PRATENSIS) AND IS AVAILABLE THROUGH GRAFF'S TURF FARM, FT. MORGAN, CO. 970-867-8873.

SEEDING

28. SEEDED NATIVE TURF AREAS SHALL BE DRILL SEEDED WITH TACKIFIER PER THE SEED MIX LISTED ON THE PLAN. SOIL PREPARATION & FINE GRADING SHALL BE INSTALLED & PERFORMED AS SPECIFIED PRIOR TO BEGINNING SEEDING; IRRIGATION SHALL BE OPERABLE PRIOR TO BEGINNING SEEDING OPERATIONS. DO NOT SEED ON FROZEN GROUND.

29. SEEDING SHALL RECEIVE & BE COVERED WITH A HYDRO-SLURRY MIX AS FOLLOWS:

- CELLULOSE/ WOOD FIBER MULCH @ 46 LBS PER 1000 SF - 15-15-15 GRANULAR ORGANIC FERTILIZER @ 9 LBS PER 1000 SF

- ORGANIC TACKIFIER/ BINDER @ 4 LBS PER 1000 SF

30. SLOPES 3:1 to 2.5:1 SHALL BE COVERED WITH NORTH AMERICAN GREEN S150 EROSION CONTROL MAT OR APPROVED EQUAL. NORTH AMERICAN GREEN, 5401 ST WENDEL CYNTHIANA RD, POSEYVILLE, IN 47633 (812) 963-3373.

31. AT THE END OF THE WARRANTY PERIOD BARE SEEDED AREAS LARGER THAN 1'X1' SHALL BE RESEEDED. FINAL APPROVAL WILL NOT BE ISSUED UNTIL ALL SEEDED AREAS ARE FULLY ESTABLISHED.

FERTILIZERS

SEEDING NOTES:

32.TURF AREAS SHALL RECEIVE THE FOLLOWING PRE-EMERGENT FERTILIZATION: NITROGEN 0-46-0 @ 50 LBS0/ ACRE AND TREBLE PHOSPHATE 0-46-0 @ 650

IRRIGATION

33. IRRIGATION SHALL BE UNDERGROUND AUTOMATIC SYSTEM WITH ELECTRIC CONTROLLER AND RAIN SENSOR. PLANT BEDS SHALL BE IRRIGATED BY DRIP EMITTERS AND TURF AREAS SHALL BE WATERED BY SPRAY HEADS. SEE IRRIGATION PLANS PREPARED BY AVOCET IRRIGATION DESIGN.


34 . THE IRRIGATION DESIGN SHALL BE IN ACCORDANCE WITH THE ARVADA I..D.C. 4-6-7-1 WATER-WISE REQUIREMENTS SECTION F.

a. A RAIN SENSOR WITH AUTOMATIC SHUT-OFF OF THE SYSTEM DURING PERIODS OF HIGH MOISTURE; b. A DRIP, SUB-SURFACE, BUBBLER OR LOW VOLUME IRRIGATION SYSTEM FOR ALL PLANTING STRIPS LESS THAN 8' WIDE AND ALL PLANTING BEDS INVOLVING TREES, SHRUBS, PERENNIALS AND GROUNDCOVER; AND c. AN IRRIGATION CLOCK WHICH ALLOWS PROGRAMMING TO MEET THE DIFFERENTIAL NEEDS OF THE SPECIFIED PLANTING PLAN.

FINISH GRADE 1" BELOW TOP OF PAVEMENT OF CURB. PAVEMENT-OR CURB MULCH ADJACENT TO PAVEMENT & CURB

2X Root Ball Diameter

Typical Tree Planting Detail

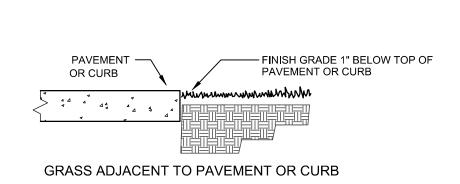

Typical Landscape Edges

1. SEE PLAN VIEW FOR: -AREA OF SEEDING AND MULCHING.

- TYPE OF SEED MIX (PERMANENT, TEMPORARY, OR LOW-GROWTH).

2. ALL BRANDS FURNISHED SHALL BE FREE FROM SUCH NOXIOUS SEEDS AS RUSSIAN OR CANADIAN THISTLE, COARSE FESCUE, EUROPEAN BINDWEED, JOHNSON GRASS, KNAP WEED AND LEAFY SPURGE.

3. THE SEEDER SHALL FURNISH TO THE CONTRACTOR A SIGNED STATEMENT CERTIFYING THAT THE SEED FURNISHED IS FROM A LOT THAT HAS BEEN TESTED BY A RECOGNIZED LABORATORY. SEED WHICH HAS BECOME WET, MOLDY, OR OTHERWISE DAMAGED IN TRANSIT OR IN STORAGE WILL NOT BE ACCEPTABLE. SEED TICKETS SHALL BE PROVIDED TO THE CITY UPON REQUEST.

4. DRILL SEEDING MIX SHALL CONFORM TO THE APPROPRIATE MIX AS SHOWN ON THE PLANS.

5. IF THE SEED AVAILABLE ON THE MARKET DOES NOT MEET THE MINIMUM PURITY AND GERMINATION PERCENTAGES SPECIFIED, THE SUBCONTRACTOR MUST COMPENSATE FOR A LESSER PERCENTAGE OF PURITY OR GERMINATION BY FURNISHING SUFFICIENT ADDITIONAL SEED TO EQUAL THE SPECIFIED PRODUCT. THE TAGS FROM THE SEED MIXES MUST BE SUPPLIED TO CONTRACTOR AND FORWARDED TO THE CITY INSPECTOR.

6. THE FORMULA USED FOR DETERMINING THE QUANTITY OF PURE LIVE SEED (PLS) SHALL BE (POUNDS OF SEED) X (PURITY) X (GERMINATION)= POUNDS OF PURE LIVE SEED (PLS).

7. ALL AREAS TO BE SEEDED AND MULCHED SHALL HAVE NATIVE TOPSOIL OR APPROVED SOIL AMENDMENTS SPREAD TO A DEPTH OF AT LEAST 6 INCHES (LOOSE DEPTH). HAUL ROADS AND OTHER COMPACTED AREAS SHALL BE LOOSENED TO A DEPTH OF 8 INCHES PRIOR TO SPREADING TOPSOIL.

8. SOIL IS TO BE THOROUGHLY LOOSENED (TILLED) TO A DEPTH OF AT LEAST 8 INCHES PRIOR TO SEEDING. THE TOP 8 INCHES OF THE SEED BED SHALL BE FREE OF ROCKS GREATER THAN 4 INCHES AND SOIL CLODS GREATER THAN 2 INCHES. SEEDING OVER ANY COMPACTED AREAS THAT HAVEN'T BEEN THOROUGHLY LOOSENED SHALL BE REJECTED.

9. SEED IS TO BE APPLIED USING A MECHANICAL DRILL TO A DEPTH OF 1/4 INCH. ROW SPACING SHALL BE NO MORE THAN 6 INCHES. MATERIAL USED FOR MULCH SHALL CONSIST OF LONG-STEMMED STRAW. AT LEAST 50 PERCENT OF THE MULCH, BY WEIGHT, SHALL BE 10 INCHES OR MORE IN LENGTH. MULCH SHALL BE APPLIED AND MECHANICALLY ANCHORED TO A DEPTH OF AT LEAST 2 INCHES. MULCH SHALL BE APPLIED AT A RATE OF 4000 LB. OF STRAW PER ACRE.

10. IF THE PERMITIEE DEMONSTRATES TO THE CITY THAT IT IS NOT POSSIBLE TO DRILL SEED, SEED IS TO BE UNIFORMLY BROADCAST AT "TWO TIMES THE DRILLED RATE, THEN LIGHTLY HARROWED TO PROVIDE A SEED DEPTH OF APPROXIMATELY 114 INCH, THEN ROLLED TO COMPACT, THEN MULCHED AS SPECIFIED ABOVE.

11. SEEDING AND MULCHING SHALL BE COMPLETED WITHIN 30 DAYS OF INITIAL EXPOSURE OR 7 DAYS AFTER GRADING IS SUBSTANTIALLY COMPLETE IN A GIVEN AREA (AS DEFINED BY THE CITY. THIS MAY REQUIRE MULTIPLE MOBILIZATIONS FOR SEEDING AND MULCHING.

12. MULCH SHALL BE APPLIED WITHIN 24-HOURS OF SEEDING.

13. TACKIFIER SHOULD BE UTILIZED TO HELP WITH STRAW DISPLACEMENT

SEEDING AND MULCHING MAINTENANCE NOTES:

1. SEEDED AND MULCHED AREAS SHALL BE INSPECTED FOR REQUIRED COVERAGE MONTHLY FOR A PERIOD OF "TWO YEARS FOLLOWING INITIAL SEEDING. REPAIRS AND RE-SEEDING AND MULCHING SHALL BE UNDERTAKEN AFTER THE FIRST GROWING SEASON FOR ANY AREAS FAILING TO MEET THE REQUIRED COVERAGE.

2. REQUIRED COVERAGE FOR STANDARD, OPEN SPACE AND LOW GROWTH SEED MIXES SHALL BE **DEFINED AS FOLLOWS:**

a. THREE (3) PLANTS PER SQUARE FOOT WITH A MINIMUM HEIGHT OF 3 INCHES. THE 3 PLANTS PER SQUARE FOOT SHALL BE OF THE VARIETY AND SPECIES FOUND IN THE CITY APPROVED MIX. b. NO BARE AREAS LARGER THAN 4 SQUARE FEET (TWO-FEET BY "TWO-FEET OR EQUIVALENT). c. FREE OF ERODED AREAS.

d. FREE FROM INFESTATION OF NOXIOUS WEEDS IN ACCORDANCE WITH SECTION 6.4 OF THE

3. REQUIRED COVERAGE FOR TURF GRASS AREAS SHALL BE DEFINED AS FOLLOWS: a. AT LEAST 80% VEGETATIVE COVER OF GRASS SPECIES PLANTED.

b. NO BARE AREAS LARGER THAN 4 SQUARE FEET (TWO-FEET BY "TWO-FEET OR EQUIVALENT). c. FREE OF ERODED AREAS.


d. FREE FROM INFESTATION OF NOXIOUS WEEDS IN ACCORDANCE WITH SECTION 6.4 OF THE GESC CRITERIA MANUAL.

4. RILL AND GULLY EROSION SHALL BE FILLED WITH TOPSOIL PRIOR TO RESEEDING. THE RESEEDING METHOD SHALL BE APPROVED BY THE CITY.

ROOTBALLS. PRUNE DEAD OR DAMAGED WOOD PRIOR TO PLANTING.

REMOVING THE CONTAINER WILL NOT

BE AN EXCUSE FOR DAMAGED

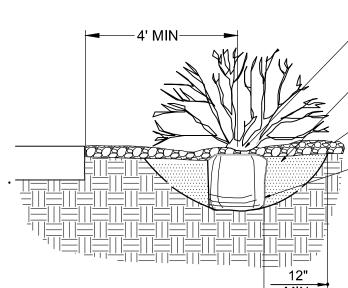

PLANT SHRUB 2" HIGHER THAN FINISHED GRADE. DIG PIT TWICE AS WIDE AS CONTAINER.

END PARKING SITUATIONS.

PLANT SHRUBS MIN. 4'-0" BEHIND CURB

IN FRONT END PARKING SITUATIONS.

HOLD GRADE 1 IN. BELOW EDGE OF

CONCRETE CURB OR SIDEWALK FRONT

APPLY SPECIFIED MULCH 3-4" DEPTH ABOVE SUBGRADE. SLOPE SIDES OF PLANTING PIT AS

SHOWN, ROUGHEN SIDES PRIOR TO BACKFILL. REMOVE CONTAINER & LOOSEN SIDES

OF ROOTBALL. BACKFILL & WATER-IN THOROUGHLY.

BROKEN OR CRUMBLING ROOTBALLS WILL BE REJECTED.

Shrub P	lanting	Detai

Edger

DO NOT CUT SINGLE LEADER. PRUNE ONLY DAMAGED.

12" NYLON TREE STRAP WITH GROMMETS ON GUY WIRE. DO NOT

1/2" DIAMETER WHITE PVC PIPE SECTION ON ENTIRE LENGTH OF

6' STEEL T-POST OR WOOD STAKE (4' EXPOSED, 2' IN UNDISTURBED

SUBGRADE) WITH SAFETY CAPS, SET TO WINDWARD SIDE AND

WITH SPECIFIED TREE WRAP MATERIAL. SECURE AT TOP WITH MASKING TAPE. DO NOT WRAP ROUGH BARK, POPULUS, OR

CIRCLE OF SHREDDED WOOD MULCH, 3" DEEP AND 4-6" AWAY

GLEDITSIA TREES. REMOVE IN SPRING AS SPECIFIED.

FROM TRUNK, TO OUTER EDGE OF PLANTING HOLE.

DOWN MINIMUM OF 2/3, CUT AND REMOVE FROM PIT.

EXCESS SOIL FROM TOP OF ROOT BALL.

COMPOSTED AMENDEMENT)

UNDISTURBED SUBGRADE

UNDERGROUND UTILITIES.

OTHER OPPOSITE; OR OTHER PRE-APPROVED STAKING METHOD.

DECIDUOUS TREE FALL PLANTING: WRAP TRUNK TO FIRST BRANCH

SET ROOT COLLAR 2 TO 3" HIGHER THAN FINISHED GRADE. REMOVE

- FORM 2" HIGH DIRT SAUCER AROUND PIT AT OUTSIDE OF TRANSITION

COMPLETELY REMOVE ALL TWINE AND WIRE BASKET. PULL BURLAP

SLOPE SIDES OF PLANTING PIT AS SHOWN, ROUGHEN SIDES PRIOR

ANY BROKEN, CRUMBLING, OR OTHERWISE DAMAGED ROOTBALL WILL

BE REJECTED. DAMAGE DURING PLANTING OPERATIONS WILL NOT BE

SPECIFIED BACKFILL MIXTURE (1/3 NATIVE SOIL, 1/3 TOPSOIL, 1/3

PRIOR TO DIGGING, THE UTILITY NOTIFICATION CENTER OF

COLORADO SHALL BE CONTACTED AT 811 TO LOCATE


14-GAUGE GALVANIZED WIRE, DOUBLE STRAND. LEAVE 1-2"

DEAD WOOD, OR CO-DOMINANT LEADERS.

FACH WIRE.

TWISTS STRAPS TO TIGHTEN AROUND TRUNK.

SLACK IN WIRE TO ALLOW FOR TRUNK MOVEMENT.

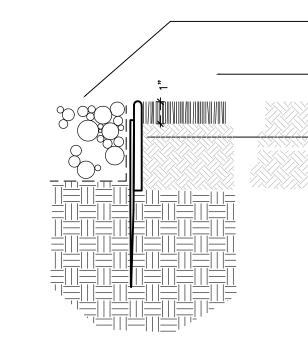

SPECIFIED MULCH DEPTH W/ WEED BARRIER

TURF AS SPECIFIED

 $\stackrel{\scriptstyle <}{}$ 1/4" THICKNESS x 4" DEPTH STEEL **EDGING WITH ROLLED PROTECTIVE TOP** OR APPROVED EQUAL

INSTALL EDGING AS RECOMMENDED BY MANUFACTURER

SET ALL EDGING 1" ABOVE FINISH GRADE AS SHOWN. EDGING SHALL ABUT ALL CONCRETE CURBS AND WALKS PERPENDICULAR, AND FLUSH W/ GRADES OF CONCRETE. ALL JOINTS TO BE SECURELY STAKED.

CITY STAFF CERTIFICATE:

DEPARTMENT OF COMMUNITY DEVELOPMENT SIGNATURE

Sheet No.

Drawn by:

Checked by:

Sheet Title

LANDSCAPE

DETAILS

2 of

**O.1 **O.2 **O.2 **O.5 **O.8 **1.5 **2.4 **3.5 **4.0 **4.7 **4.6 **4.0 **3.5 **2.9 **2.2 **1.5 **1.2 **1.1 **0.9 **0.7 **0.5 **0.3 **0.2 **0.1 **0.1 **0.1 **0.1 **0.1 **0.1 **0.1 **0.1 **0.1 **0.0

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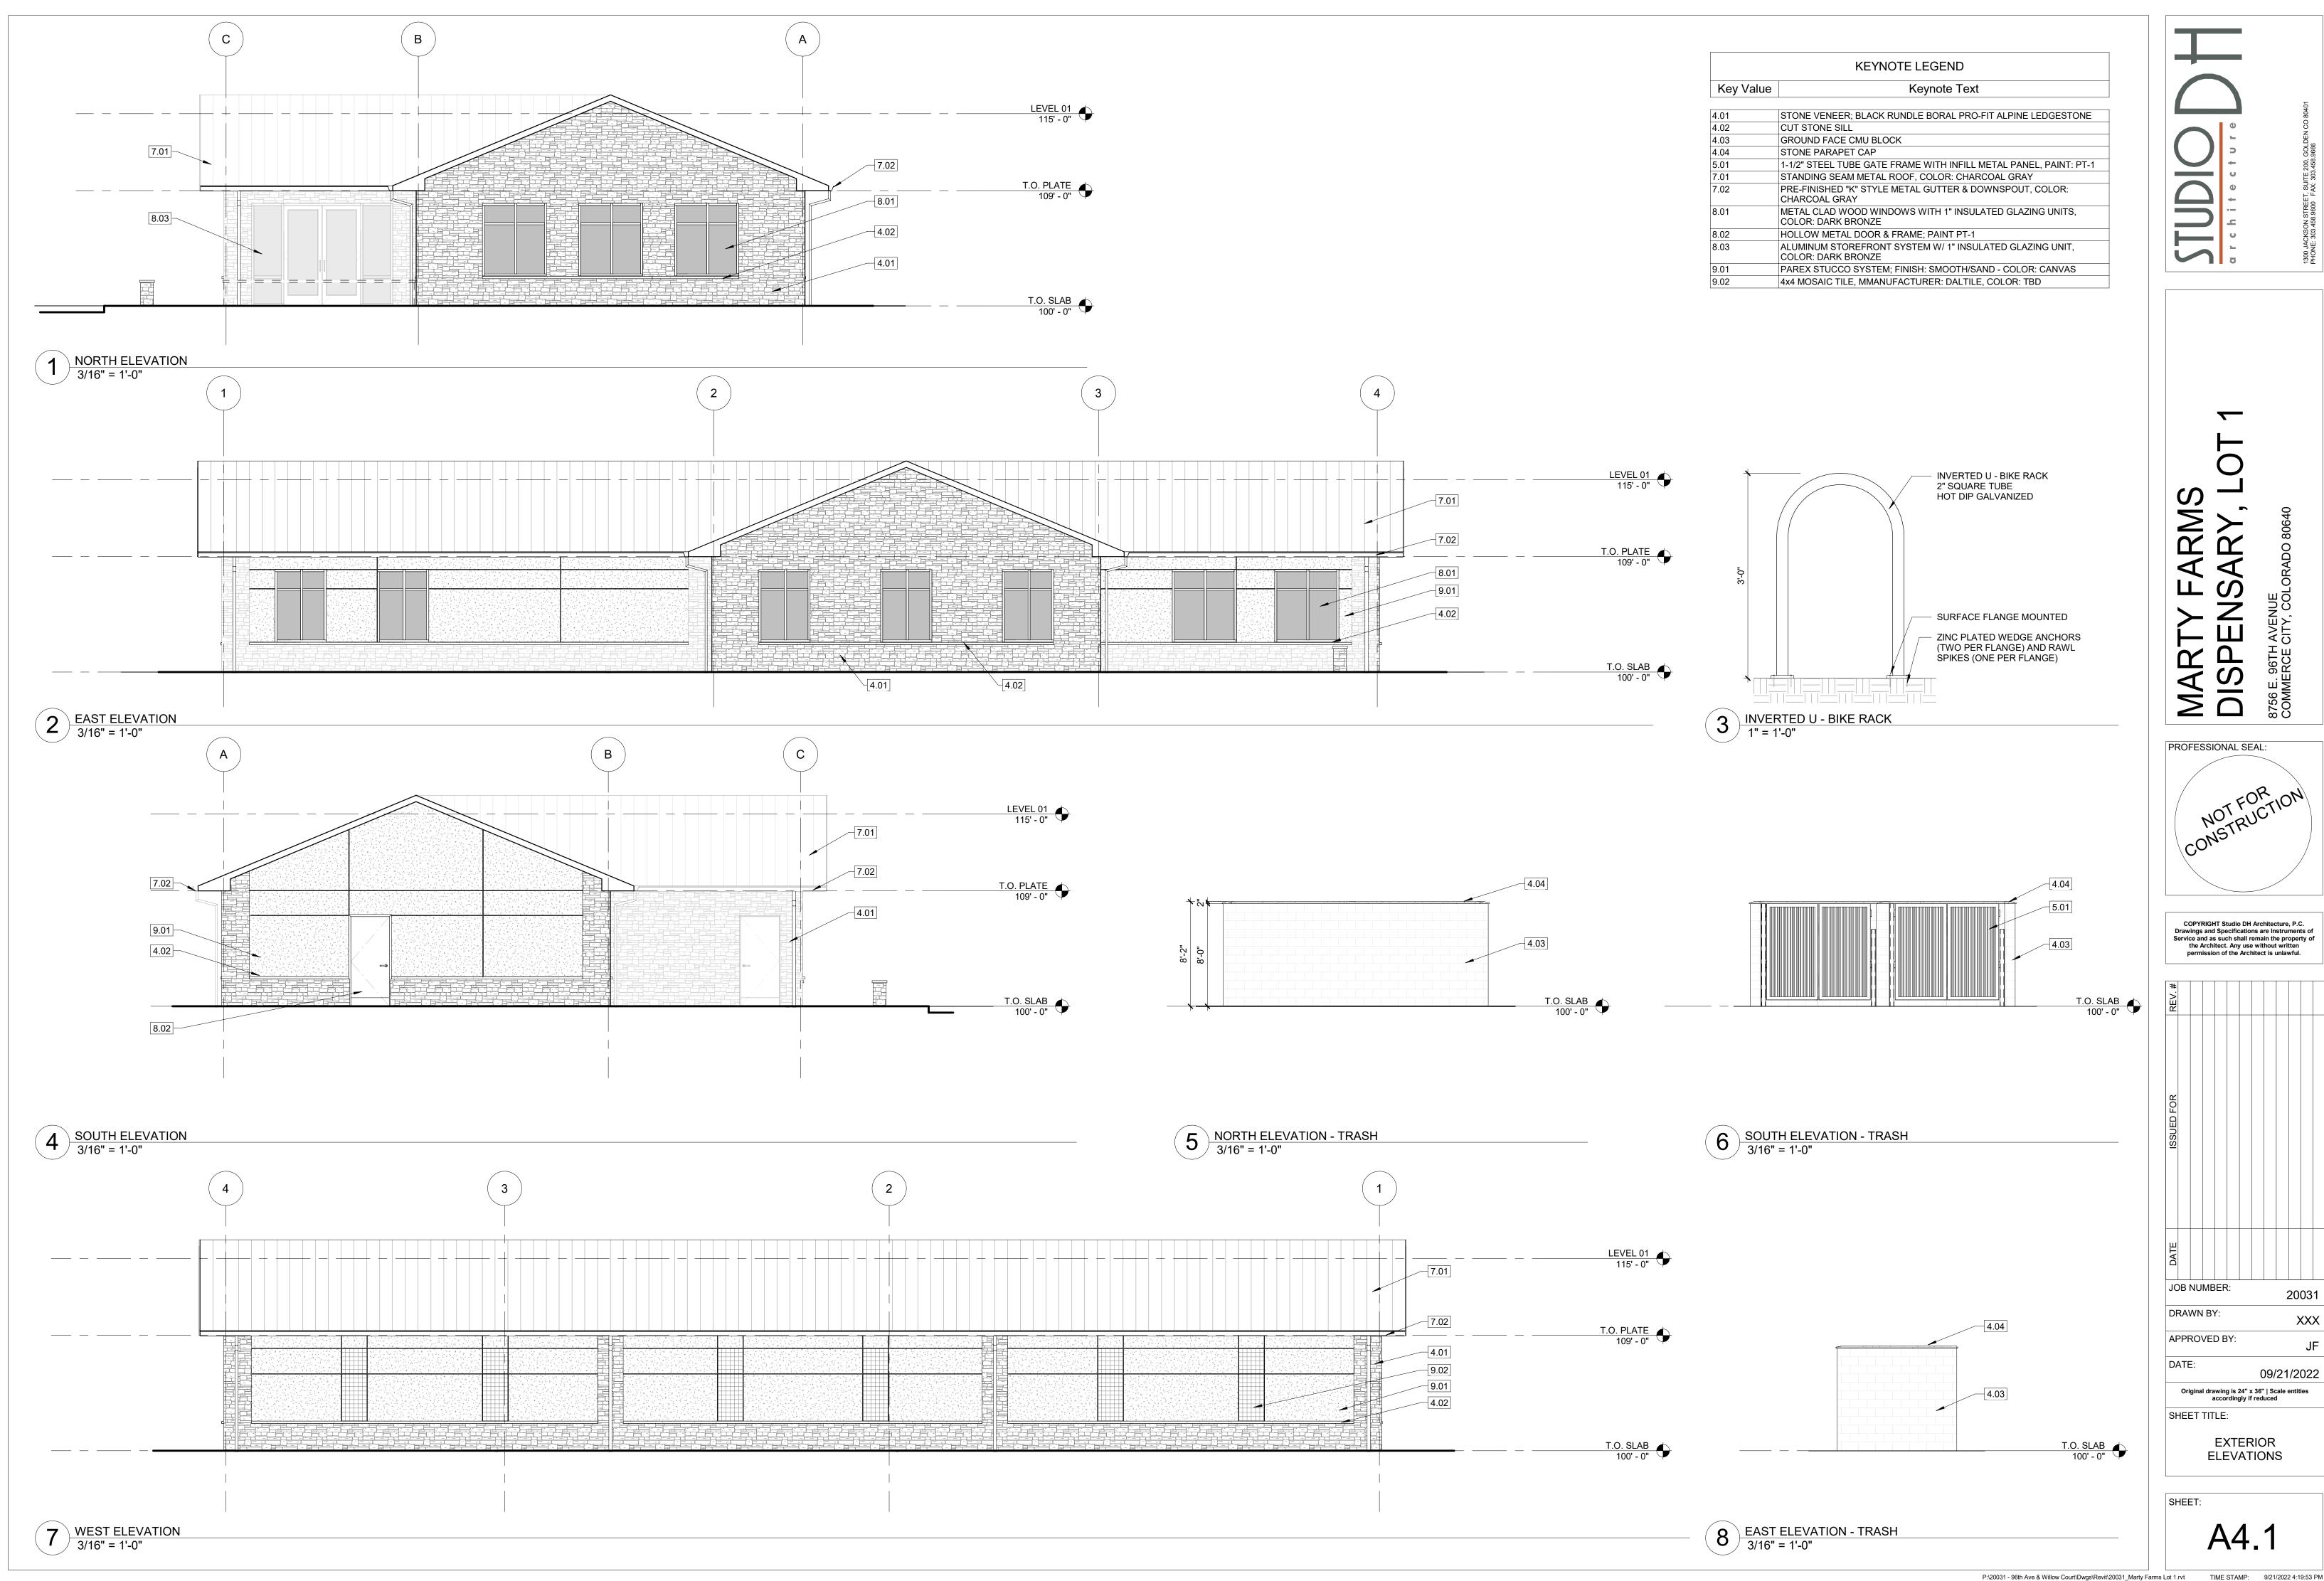
Plan View Scale - 1" = 20ft

Schedule											
Symbol	Label	Quantity	Manufacturer	Catalog Number	Description	Lamp	Number Lamps	Filename	Lumens Per Lamp	Light Loss Factor	Wattage
	AA	1	COOPER LIGHTING SOLUTIONS - McGRAW- EDISON (FORMERLY EATON)	GWC-SA1C-735-U-T4W	GALLEON WALL LUMINAIRE (1) 70 CRI, 3500K, 1050mA LIGHTSQUARE WITH 16 LEDS AND TYPE IV WIDE OPTICS Retail, Roadway, Sidewalk, Site, Street, Substation, Security, Corrosion Resistant, Vandal Resistant, Wet Location ABSOLUTE PHOTOMETRY IS BASED ON CALIBRATION FACTORS CREATED USING LAB LUMEN STANDARDS IN GONIOPHOTOMETER WITH TEST DISTANCE OF 28.75 FEET		16	GWC-SA1C-735-U-T4W (1).ies	441	1	59
	CC	6	COOPER LIGHTING SOLUTIONS - McGRAW- EDISON (FORMERLY EATON)	GWC-SA1C-735-U-T4FT	GALLEON WALL LUMINAIRE (1) 70 CRI, 3500K, 1050mA LIGHTSQUARE WITH 16 LEDS AND TYPE IV FORWARD THROW OPTICS Retail, Roadway, Sidewalk, Site, Street, Substation, Security, Corrosion Resistant, Vandal Resistant, Wet Location ABSOLUTE PHOTOMETRY IS BASED ON CALIBRATION FACTORS CREATED USING LAB LUMEN STANDARDS IN GONIOPHOTOMETER WITH TEST DISTANCE OF 28.75 FEET		16	GWC-SA1C-735-U-T4FT.ies	446	1	59

J. LANG Date 09/19/2022 Scale Not to Scale Drawing No.

96TH AND WILLOW STREET COMMERCE CITY, COLORADO

Summary



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